

LOCALITY PLAN

EXTRACTED FROM GOOGLE MAPS © 2020

LOT DATA		ΓDATA
	27	RP 132756

REFER TO SURVEY PLAN BY AXIS SURVEYS FOR REFERENCE PSM TO BE USED AS REFERENCE FOR ALL SETOUT INFORMATION DURING CONSTRUCTION. CONTRACTOR TO CONFIRM SURVEY SETOUT REFERENCE WITH REGISTERED SURVEYOR PRIOR TO CONSTRUCTION. ALL LEVELS TO AUSTRALIAN HEIGHT DATUM (AHD). GRID COORDINATE SYSTEM AS SPECIFICIED BY SURVEYOR

MELIORA ENGINEERING ACCEPTS NO RESPONSIBILITY FOR THE ACCURACY OF EXISTING UNDERGROUND SERVICES WHICH ARE PLOTTED FROM AUTHORITY RECORDS BY THE SURVEYOR. DOCUMENTED DESIGNS MAY BE SUBJECT TO ONGOING CHANGES UNTIL RECEIPT AND REVIEW OF MINIMUM QUALITY 'LEVEL A' EXISTING SERVICE LOCATION RESULTS ALONG FULL LENGTH OF PROPOSED MAIN ALIGNMENTS. MELIORA WILL NOT BE HELD LIABLE FOR COST INCREASES OR TIME EXTENSION RESULTING FROM NECESSARY DESIGN CHANGES TO ACHIEVE AUTHORITY CODE

17.02.23 SM MB

GENERAL LEGEND

DETAIL CALLOUT & REFERENCE

SETOUT POINT

CONTOURS LEGEND

DESIGN/FINISHED SURFACE CONTOURS EXISTING SURFACE CONTOURS

PROPOSED LOT BOUNDARIES PROPOSED EASEMENT

DIAL BEFORE

____ 180._____ ______



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_____ SWD— — ____

- OE- - OE- - -

---dE---dE---dE-

---dG---dG---dG-

- RM- - - RM- - -

---dS---dS---dS-

— - - dSRM- - - dSRM-

_ w _ _ _ w _ _ _

- - - dw- - - dw- - - dw-

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EXISTING PROPERTY BOUNDARY EXISTING BOUNDARY ADJACENT EXISTING EASEMENT CONTOURS EXISTING MAJOR CONTOURS EXISTING MINOR EARTHWORKS EXISTING BATTER TOE FARTHWORKS EXISTING BATTER TOP

BUILDING EXISTING BUILDING EXISTING ROOF/FAV MISC FENCE / GATE EXISTING ROAD EXISTING KERB ROAD EXISTING CENTERLINE ROAD EXISTING EDGE BITUMEN

COMMUNICATIONS EXISTING DRAINAGE EXISTING CENTERLINE DRAINAGE EXISTING TEXT ELECTRICAL EXISTING OVERHEAD ELECTRICAL EXISTING UNDERGROUND ELECTRICAL EXISTING CENTERLINE DBYD

GAS EXISTING CENTERLINE DBYD SEWER EXISTING CENTERLINE SEWER EXISTING RISING MAIN SEWER EXISTING CENTERLINE DBYD SEWER RISING MAIN EXISTING CENTERLINE DBYD

TELECOMMUNICATIONS EXISTING TELECOMMUNICATIONS EXISTING CENTERLINE DBYD - - dT - - - dT - - - dT -FIBER OPTIC CABLES EXISTING CENTERLINE DBYD WATER EXISTING CENTERLINE WATER EXISTING CENTERLINE DBYD ARANDONED SERVICES EXISTING RETAINING WALL - BOULDER

FARTHWORKS EXISTING DRAIN EARTHWORKS EXISTING DRAIN CONCRETE

EXISTING VEGETATION 'TREE PROTECTION ZONE'

EXISTING RETAINING WALL - BLOCK

- ALL WORKS TO BE CARRIED OUT STRICTLY IN ACCORDANCE WITH THE APPROVAL DEVELOPMENT CONDITIONS, CURRENT COUNCIL (AND OTHER RELEVANT AUTHORITY) GUIDELINES AND STANDARD DRAWINGS UNLESS DIRECTED OTHERWISE.
- A LEGIBLE COPY OF THE COUNCIL APPROVED DRAWINGS AND DOCUMENTS (INCLUDING CONDITIONS) MUST BE MAINTAINED AND KEPT ON SITE FOR INSPECTION BY SITE WORKERS AND
- REFER TO MANDATORY REFERENCE NOTES ON THIS PAGE
- REFER TO ARCHITECTURAL, HYDRAULIC, MECHANICAL AND ELECTRICAL DRAWINGS FOR ADDITIONAL SITE SERVICES TO BE CO-ORDINATED WITH AND CONSIDERED DURING CONSTRUCTION
- THE DEVELOPER IS TO NOMINATE THE SUPERINTENDENT FOR THE WORKS AND NOTIFY ALL RELEVANT PARTIES PRIOR TO COMMENCEMENT OF CONSTRUCTION, CONTRACTOR IS TO REQUEST DETAILS OF SUPERINTENDENT PRIOR TO CONSTRUCTION.
- DE IAILS OF SUPERINI ENDEN I PRIOR TO CONSTRUCTION.
 THE CONTRACTOR IS TO ALLOW TO ERECT AN INFORMATION SIGN ON THE SUBJECT PROPERTY PRIOR TO CONSTRUCTION, IN ACCORDANCE WITH CONDITIONS AND COUNCIL REQUIREMENTS ALL DIMENSIONS ON THE DRAWINGS ARE IN METRES UNLESS SHOWN OTHERWISE. DO NOT SCALE OFF THESE DRAWINGS. IF IN DOUBT ASK SUPERINTENDENT FOR CLARIFICATION.
 IT IS THE CONTRACTOR'S RESPONSIBILITY TO LOCATE ALL EXISTING SERVICES ON SITE PRIOR TO CONSTRUCTION AND LAWLOCK MAN CONTRACTOR'S RESPONSIBILITY.
- CONSTRUCTION AND LAYING OF ANY SERVICES AND ADVISE THE SUPERINTENDENT OF ANY DIFFERENCES FROM THE DRAWINGS. ANY DAMAGE TO EXISTING SERVICES WILL BE REPAIRED AT
- THE CONTRACTORS COST.

 ALL SETTING OUT IS THE RESPONSIBILITY OF THE CONTRACTOR PRIOR TO WORKS COMMENCING ON SITE. THE SUPERINTENDENT'S SURVEYOR SHALL PEG ALL ALLOTMENT BOUNDARIES, PROVIDE CO-ORDINATE INFORMATION TO THESE PEGS AND PLACE BENCH MARKS. THE CONTRACTOR SHALL SET OUT THE WORKS FROM AND MAINTAIN THESE PEGS.

 THE CONTRACTOR IS TO DEVELOP A SUITABLE CONSTRUCTION MANAGEMENT PLAN (CMP) TO ADDRESS RELEVANT DEVELOPMENT APPROVAL CONDITION CMP REQUIREMENTS INCLUDING (BUT NOT).
- PURSUANT TO THE ENVIRONMENTAL PROTECTION ACT 1994. DEVELOPMENT INVOLVING THE FORSOLANT OTHE EVINKONMENTAL PROTECTION AND THE PASS EXCEPTION HER INVOLVED THE EMISSION OF NOISE AND DUST FROM CONSTRUCTION ACTIVITIES MUST ENSURE EMISSIONS ARE IN ACCORDANCE WITH THE REQUIREMENTS OF THE ACT. WORKS SHALL BE PROGRAMME SO AS NOT TO DISTURB NEARBY HOUSEHOLDERS EITHER 97 DUST, NOISE, ELODDING OR DISCONNECTION OF SERVICES. (FOR MARKETING REASONS IT IS ESSENTIAL THE SITE IS KEPT IN A TIDY STATE EVEN DURING CONSTRUCTION. THE CONTRACTOR SHALL ALLOW ALL COSTS TO CLEAN-UP THE SITE INCLUDING REMOVAL OF RUBBISH AND EXCESS SOIL, STACKING OF LOOSE PIPES AND GRADING OF DISTURBED AREAS WEEKLY).
- TRANSPORTATION ROUTES FOR IMPORTED AND EXPORTED MATERIALS TO BE APPROVED BY
- TRANSPORTATION ROUTES FOR IMPORTED AND EXPORTED MATERIALS TO BE APPROVED BY THE LOCAL COUNCIL.

 UNDERTAKE ACTIVITIES ASSOCIATED WITH THE OPERATION OF THE USE ONLY BETWEEN THE HOURS OF 6.30am To 16.30pm MONDAY TO FRIDAY UNLESS STATED OTHERWISE IN THE DEVELOPMENT CONDITIONS.

 OBTAIN NECESSARY PERMITS AND APPROVALS FROM RELEVANT AUTHORITIES BEFORE COMMENCIAN MORE AND THE ORDER TO THE THE OPERATION OF THE ORDER TO THE ORD
- COMMENCING WORK ON SITE OR IN THE VERGE. NOTIFY RELEVANT SERVICE AUTHORITIES BEFORE COMMENCING WORK ON SITE OR IN THE VERGE
- BEFORE COMMENCING WORK ON SITE OR IN THE VERGE

 11. ANY REQUIRED SERVICE CONDUITS (INCLUDING 12 LED IN CONDUITS) FOR THE DEVELOPMENT

 SHALL BE INSTALLED TO COUNCIL, ENERGEX, TELSTRA, OPTUS AND GAS AUTHORITY STANDARDS

 AT LOCATIONS DETERMINED BY THE RELEVANT AUTHORITIES (OR RELEVANT ELECTRICAL

 CONSULTANTS) WITH COSTS BORNE BY THE DEVELOPER. CONTRACTOR TO CONFIRM FINAL

 SPECIFICATION FOR SERVICE CONDUITS PRIOR TO CONSTRUCTION TO BE IN ACCORDANCE WITH

 CONDUITED THE PROPERTY OF THE PROPERTY CONSULTANT/AUTHORITY DRAWINGS WHICH WILL SUPERSEDE ANY LOCATIONS AS SHOWN ON MELIORA CIVIL PLANS, NBN & ELEC 'LEAD IN' CONDUITS TO SATISFY AS/NZS 3000 (SAA WIRING RULES), INCLUDE PROTECTIVE COVER STRIP ABOVE AND DRAW WIRES WITH LIPRIGHT CONDUITS ABOVE SERVICE TO ID LOCATION. EXTERNAL (AUTHORITY) ELEC/COMMS CONNECTIONS WILL BE BY
- UTHERS.
 SURVEY BENCHMARKS ARE TO BE CONFIRMED ONSITE PRIOR TO CONSTRUCTION AND USED AS REFERENCE FOR ALL CONSTRUCTION SETOUT AND PERMANENT SURVEY MARKS ARE TO BE INSTALLED AS PER COUNCIL STANDARDS.
- 13. THESE DRAWINGS DO NO DETAIL TEMPORARY WORKS. CONSTRUCTION METHODS AND TEMPORARY WORKS ARE RESPONSIBILITY OF THE CONTRACTOR.
- 14. REGARDI ESS OF DRAWING ISSUE STATUS. DOCUMENTED DESIGNS MAY BE SUBJECT TO ONGOING ALONG FULL LENGTH OF PROPOSED MAIN ALIGNMENTS. MELIORA WILL NOT BE HELD LIABLE FOR COST INGREASES OR TIME EXTENSION RESULTS ALONG FULL LENGTH OF PROPOSED MAIN ALIGNMENTS. MELIORA WILL NOT BE HELD LIABLE FOR COST INGREASES OR TIME EXTENSION RESULTING FROM NECESSARY DESIGN CHANGES TO
- ACHIEVE AUTHORITY CODE COMPLIANCE.

 15. FIRE ANT MOVEMENT CONTROLS: THE QUEENSLAND GOVERNMENT HAS IMPLEMENTED IMPROVEMENT CONTROLS IN AREAS OF QUEENSLAND (BIOSECURITY ZONES) WHERE THIS PEST SPECIES HAS BEEN DETECTED. THESE CONTROLS APPLY TO INDIVIDUALS AND COMMERCIAL OPERATORS AND RESTRICT THE MOVEMENT OF MATERIALS THAT COULD CARRY FIRE ANTS WHICH INCLUDE SOIL, TURE, POTTED PLANTS, MULCH, BALED HAY OR STRAW, ANIMAL MANURES, MINING OR QUARRY PRODUCTS, PENALTIES FOR NON-COMPLANCE WITH MOVEMENT CONTROLS WITHIN FIRE ANT BIOSECURITY ZONES APPLY UNDER THE BIOSECURITY ACT 2014. CONTRACTORS AND THEIR SUB-CONTRACTORS WILL BE LIABLE FOR BREACHES AND ARE TO FOLLOW LEGISLATION AT
- 16. CUI TURAL HERITAGE: ABORIGINAL CUI TURAL IS PROTECTED UNDER THE CUI TURAL HERITAGE ACT 2003. AS PER THE LEGISLATION, CONTRACTORS CARRYING OUT ACTIVITIES MUST TAKE ALL REASONABLE AND PRACTICABLE MEASURES FOR ENSURING ACTIVITIES ARE MANAGED TO AVOID OR MINIMISE HARM TO ABORIGINAL CULTURAL HERITAGE. CONTRACTORS ARE TO FULFIL THIS DUTY

SAFETY IN DESIGN (SID) NOTES

- CONTRACTOR IS TO COMPLETE A HAZARD AND RISK ASSESSMENT PRIOR TO CONSTRUCTION AND PROPOSE SUITABLE ACTION/RESPONSE TO ADDRESS ALL HIGH AND ABNORMAL RISK ITEMS
 TEMPORARY WARNING DEVICES TO BE ERECTED AS PER "MANUAL OF UNIFORM TRAFFIC CONTROL DEVICES" AND RELEVANT COUNCIL GUIDELINES TO ENSURE SAFE WORKING CONDITIONS FOR WORKERS, PEDESTRIANS AND PASSING TRAFFIC.
 TRY TO AVOID WORKING IN CONFINED SPACES. IF CONFINED SPACES WORK CAN'T BE AVOIDED PROVIDE SAFE WORK METHOD
- STATEMENT (SWMS) ADDRESSING MITIGATION OF RISKS. PROVIDE ADEQUATE SIGNAGE TO TEMPORARY AND PERMANEN
- CONFINED SPACES TO AS2865
 THE CONTRACTOR IS TO ENSURE THEY HOLD ALL RELEVANT TICKETS, CERTIFICATION AND PERMITS SUITABLE FOR THE
 PROPOSED WORKS PRIOR TO CONSTRUCTION
 IT IS THE CONTRACTOR'S RESPONSIBILITY TO LOCATE ALL EXISTING SERVICES ON SITE PRIOR TO CONSTRUCTION AND LAYING
 OF ANY SERVICES. ANY LIBBLITY RESULTING FROM DAMAGE TO EXISTING SERVICES WILL BE BORNE BY THE CONTRACTOR.
 CONTRACTOR TO BEWARE EXISTING GAS PIPELINES IN VICINITY OF WORKS, AND ENSURE AUTHORITY REQUIREMENTS ARE ADDRESSED DURING CONSTRUCTION ACTIVITIES
- ALL TRENCH EXCAVATION AND CONSTRUCTION SHALL COMPLY WITH THE REQUIREMENTS OF THE COMMONWEALTH WORK
- REL TRENDE PACKATION AND CONSTRUCTION AND CONSTRUCTION THE REQUIREMENTS OF THE COMMINIONMENT HOWAY HEALTH AND SAFETY ACT 2011.

 CONSTRUCTION BARRIERS THAT CONTRIBUTE TO SAFETY, SUCH AS HANDRAILS AND TOE BOARDS, FALL ARREST SYSTEMS ACCESS STAIRS ETC AS EARLY AS POSSIBLE, PROVIDE SAFETY BARRIERS AT EDGES OF OPENINGS AND ELEVATED AREAS, REVIEW ADEQUACY OF WORKING SPACE AVAILABLE FOR CONSTRUCTION ACTIVITIES. ENSURE SEPARATION OF PLANT AND
- PERSONNEL/PROPERTY ON SITE, INCLUDING MOVEMENT OF BOTH
- PROVIDE PROTECTION TO AND SEPARATION FROM ELECTRICAL OVERHEAD WIRING SYSTEMS DURING CONSTRUCTION. PROVIDE PROTECTION TO AND SEPARATION PROMEELCH RICEL OVERHEAD WIRING STSTEMS DURING CONSTRUCTION.
 ALL TRENCHES MORE THAN 1.5m DEEP (BASE OF TRENCH TO TOP OF TRENCH OR TOP OF SPOIL ADJACENT TO TRENCH WHICHEVER IS GREATER) ARE TO BE SHORED OR BENCHED OR BATTERED AT 1in1 MAX. WRITTEN RISK ASSESSMENTS AREA
 ADVISED FOR ACCESS TO OPEN EXCAVATIONS AND SAFE ACCESS IS TO BE MAINTAINED FOR ALL PERSONS IN THE TRENCH AT
 ALL TIMES IN CASE OF INJUDITATION OR WALL COLLAPSE/ROULPHENT L
 LOCATE STOCKPILES AWAY FROM BATTERS/EXCAVATIONS AND EXISTING SERVICES
 SEEK ADVICE FROM SUITABLY QUALIFIED GEOTECHNICAL ENGINEER PRIOR TO CONSTRUCTION ACTIVITIES ADJACENT TO OPEN
- EXCAVATIONS AND/OR RETAINING WALLS

ENGINEERING INSPECTIONS, AS-CONSTRUCTED DOCUMENTATION & CERTIFICATION THE CONTRACTOR IS RESPONSIBLE TO MAINTAIN COMMUNICATION WITH THE CLIENT AND MELIORA ENGINEERING RE

THE CONTRACTOR IS RESPONSIBLE TO MAINTAIN COMMUNICATION WITH THE CLIENT AND MELIORA ENGINEERING REGARDING PROGRAM AND THINING OF CONSTRUCTION PHASE.

ALL COMPONENTS OF CIVIL WORKS MAY BE SUBJECT TO INSPECTION REQUIREMENTS. THE CONTRACTOR IS TO ALLOW FOR THE BELOW INSPECTIONS AT A MINIMUM. THE CONTRACTOR IS TO PROVIDE NOTICE IN WRITING TO MELIORA ENGINEERING (AND CC IN CLIENT TO EMAILS) A MINIMUM OF THREE (3) BUSINESS DAYS PRIOR TO INSPECTIONS.

THE FOLLOWING INSPECTIONS (WITNESS HOLD POINTS) ARE REQUIRED FOR THE PROJECT

- EXISTING SURFACE PROOF ROLL (POST STRIPPING) PRIOR TO FILLING UNDER PAVEMENTS
- CIVIL DRAINAGE PIPES IN-TRENCH, PRIOR TO BACKFILL CONCRETE DRIVEWAY REINFORCEMENT INSPECTION
- CIVIL WORKS PRACTICAL COMPLETION INSPECTION

IN ADDITION TO FACILITATING ENGINEERING INSPECTIONS. THE CONTRACTOR IS TO MAINTAIN COMPREHENSIVE CONSTRUCTION RECORDS (PHOTOS, AS-CONSTRUCTED SURVEY, MATERIAL DOCKETS ETC) AND IS TO ISSUE TO MELIORA ENGINEERING AT THE END

PLEASE NOTE THAT RPEQ CERTIFIED CONSTRUCTION CERTIFICATION CANNOT BE PROVIDED WHERE MELIORA HAS NOT ATTENDED INSPECTIONS AND ADEQUATE AS-CONSTRUCTED DOCUMENTATION HAS NOT BEEN SUPPLIED. CONTRACTOR IS LIABLE FOR ALL COSTS & RE-WORK REQUIRED WHERE ADEQUATE CONSTRUCTION INSPECTIONS/RECORDS HAVE NOT BEEN FACILITATED & SUPPLIED.

GEOTECHNICAL SUPERVISION & CERTIFICATION
WHERE EARTHWORKS FILLING IS REQUIRED UNDER STRUCTURES, LEVEL 1 CERTIFICATION IS TO BE PROVIDED BY A GEOTECHNICAL ENGINEERING TO CONFIRM FIT FOR USE TO SATISFY STRUCTURAL ENGINEERING REQUIREMENTS. FOR FURTHER INFORMATION AND REQUIREMENTS FOR GEOTECHNICAL INVOLVEMENT, REFER TO NOTES ON EARTHWORKS LAYOUT PLAN.

MANDATORY REFERENCE DOCUMENTATION

ALL WORKS TO BE CARRIED OUT IN ACCORDANCE WITH THE CURRENT COUNCIL (LOCAL AUTHORITY DEVELOPMENT (DA) CONDITIONS) AS WELL AS THE WATER AUTHORITY CONDITIONS ALL RELEVANT AUTHORITY APPROVALS AND CONDITIONS ARE TO BE REVIEWED (AND REQUESTED IF NOT ALREADY RECEIVED) BY CONTRACTOR PRIOR TO CONSTRUCTION.

SPECIFICATIONS AND WITH ALL OTHER WRITTEN INSTRUCTIONS ISSUED. REFER TO ARCHITECTURAL DRAWINGS FOR SETTING OUT AND DETAIL DIMENSIONS. IN CASE OF DISCREPANCY, PRECEDENCE IS GIVEN TO DRAWINGS. THEN NOTES. THEN SPECIFICATION, REFER DISCREPANCIES TO SUPERINTENDENT BEFORE PROCEEDING WITH WORK

- FURTHER, ALL WORKS TO BE CARRIED OUT IN ACCORDANCE WITH

 1. COUNCIL (LOCAL AUTHORITY) GUIDELINES, PLANNING SCHEME POLICIES (PSPs), SPECIFICATIONS AND STANDARD DRAWINGS

 2. RELEVANT LEGISLATION INCLUDING (BUT NOT LIMITED TO):
- WORK HEALTH & SAFETY ACT 2011 ENVIRONMENTAL PROTECTION & BIODIVERSITY ACT 1999
- BIOSECURITY ACT 2015, REFER TO WWW.DAF.QLD.GOV.AU SUSTAINABLE PLANNING ACT 1999
- SUSTAINABLE PLANNING ACT 1999
 RELEVANT AUSTRALIAN STANDARDS INCLUDING (BUT NOT LIMITED TO):
 AS3500.3-2018 (PLUMBING & DRAINAGE)
 AS2865-2009 (CONFINED SPACES)
- AS3798-2007 (EARTHWORKS)
- AS/NZS 2890.1-2004 (PARKING FACILITIES)
- AS1742.3-2019 (SIGNAGE & LINE MARKING) SS BY MUTCD AS4049 2-2005 (PAVEMENT MARKING MATERIALS)
- INTERNATIONAL EROSION CONTROL AUTHORITY (IECA) & STANDARD DRAWINGS

- INTERNATIONAL ENGISION CONTINUE AD THRONT (ECS) & STANDARD DRAWINGS
 MANUAL OF UNIFORM TRAFFIC CONTROL DEVICES (MUTCD)
 SOUTH EAST QUEENSLAND WATER SUPPLY AND SEWERAGE DESIGN AND

COUNCIL DA REFERENCE #: 9406/2022/RAL

FOR APPROVAL

01 ISSUE FOR APPROVAL

ALL PLANS TO BE READ IN CONJUNCTION WITH ALL INFORMATION AND NOTES ON DRG. No. C01 AND ALL RELEVANT SPECIFICATIONS

> RPEQ No. 21258 DATE: FEB 2023 MAME

MELIORA


PROSPERITY CAPITAL PRINCIPLES PL 11 SHANAHAN PARADE REDBANK PLAINS

LOCALITY, SCHEDULE & GENERAL NOTES EXISTING FEATURES LEGEND


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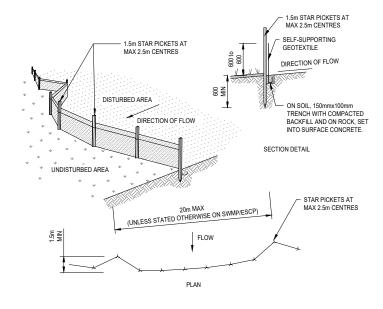


TYPICAL STABILISED SITE ACCESS DETAIL

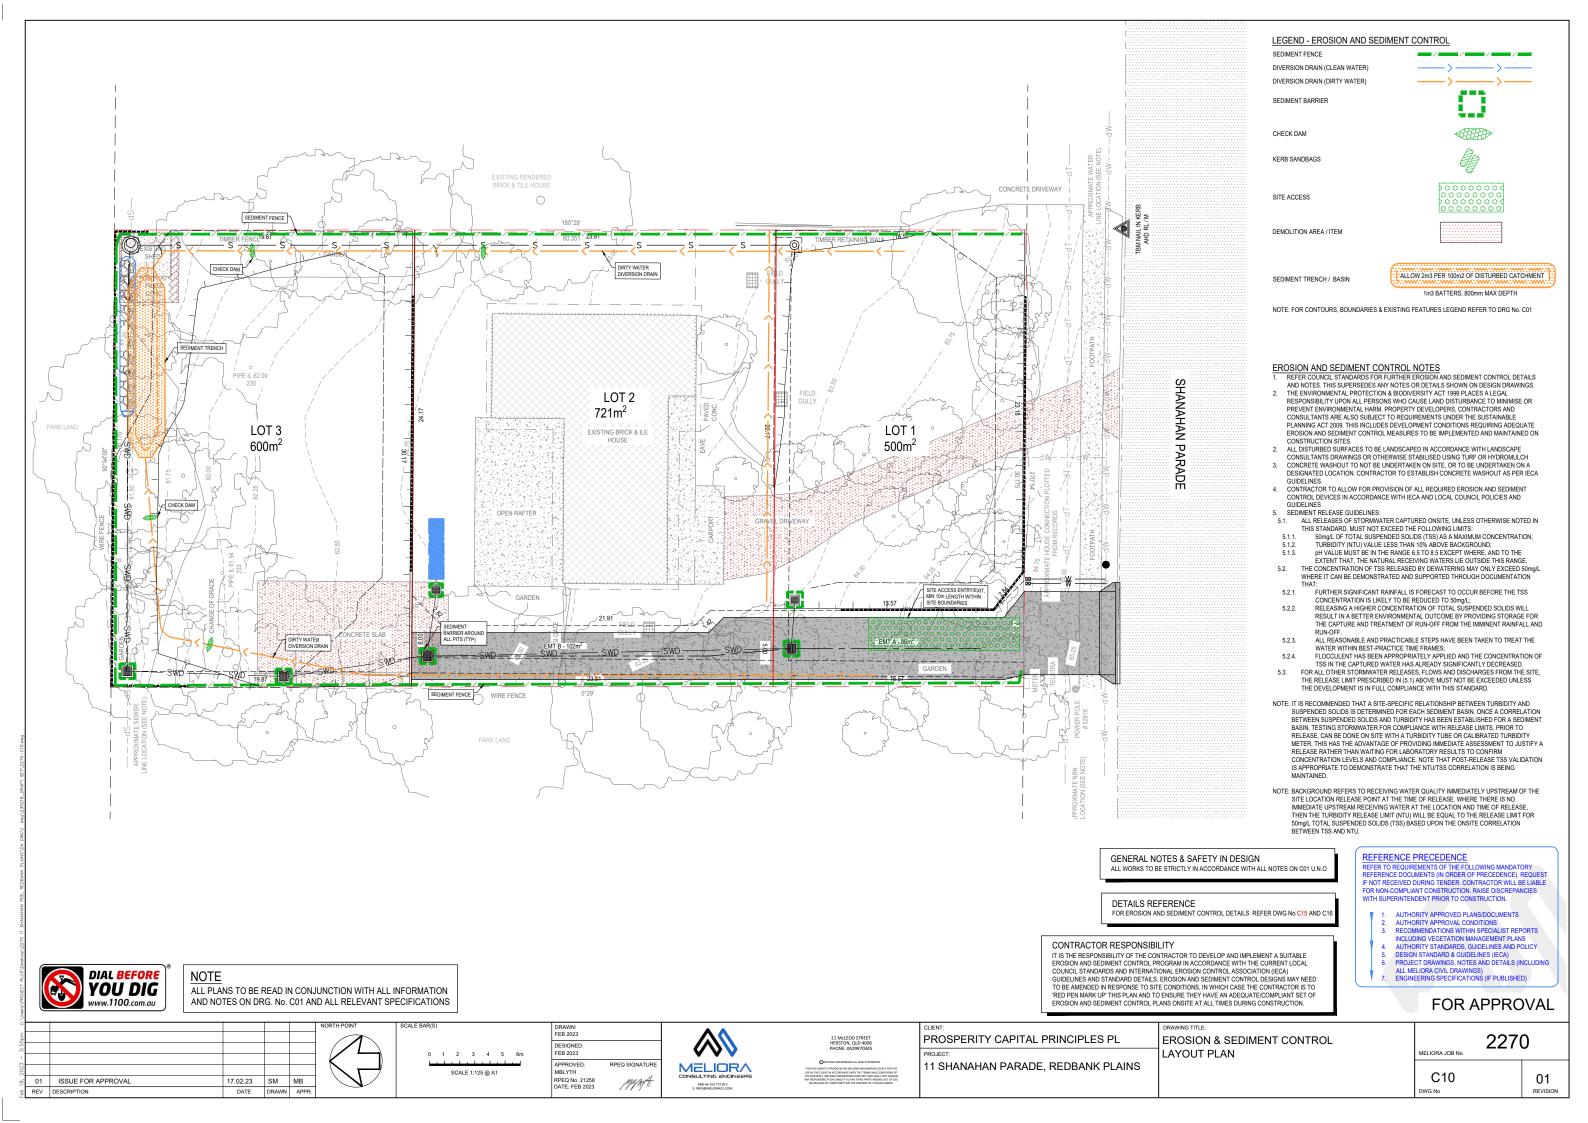

TYPCIAL ROCK CHECK DAM DETAILS


IECA STANDARD DRAWING REFERENCE - TAKES PRECEDENCE REFER TO IECA STANDARD DRAWING SD-RCDD1 WHICH SUPERSEDES ALL NOTES AND DETAILS WITHIN THE DETAIL ABOVE

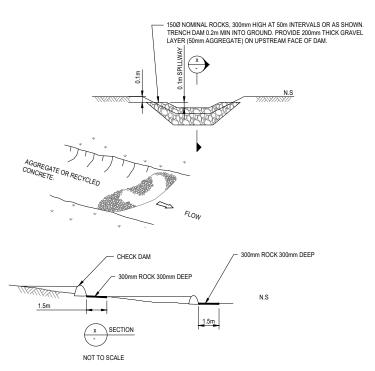


TYPICAL SEDIMENT FENCE DETAIL

IECA STANDARD DRAWING REFERENCE - TAKES PRECEDENCE REFER TO IECA STANDARD DRAWING SD-SF01 WHICH SUPERS ALL NOTES AND DETAILS WITHIN THE DETAIL ABOVE

ALL PLANS TO BE READ IN CONJUNCTION WITH ALL INFORMATION AND NOTES ON DRG. No. C01 AND ALL RELEVANT SPECIFICATIONS

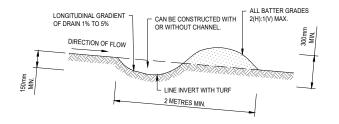

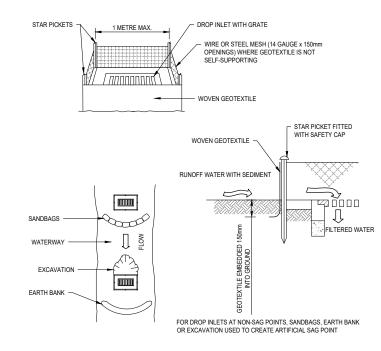

CONSTRUCTION NOTES

- 1. FABRICATE A SEDIMENT BARRIER MADE FROM GEOTEXTILE OR STRAW BALES.
- 2. IN WATERWAYS, ARTIFICIAL SAG POINTS CAN BE CREATED WITH SANDBAGS OR EARTH BANKS AS SHOWN IN THE DRAWING.
- 3. DO NOT COVER THE INLET WITH GEOTEXTILE UNLESS THE DESIGN IS ADEQUATE TO ALLOW FOR ALL WATERS TO BYPASS IT.

TYPICAL GEOTEXTILE INLET FILTER DETAIL

IECA STANDARD DRAWING REFERENCE - TAKES PRECEDENCE
REFER TO IECA STANDARD DRAWING SD-ESC02 WHICH SUPERSEDES ALL NOTES AND DETAILS WITHIN THE DETAIL ABOVE

TYPICAL EARTH BANK - LOW FLOW

IECA STANDARD DRAWING REFERENCE - TAKES PRECEDENCE
REFER TO IECA STANDARD DRAWING SD-CD01 TO CD04 WHICH PERSEDES ALL NOTES AND DETAILS WITHIN THE DETAIL ABOVE LAYOUT & NOTES REFERENCE FOR E&SC LAYOUT PLAN REFER DWG No C10.

REFERENCE PRECEDENCE

REFER TO REQUIREMENTS OF THE FOLLOWING MANDATORY REFERENCE DOCUMENTS (IN ORDER OF PRECEDENCE). REQUEST IF NOT RECEIVED DURING TENDER. CONTRACTOR WILL BE LIABLE FOR NON-COMPLIANT CONSTRUCTION. RAISE DISCREPANCIES WITH SUPERINTENDENT PRIOR TO CONSTRUCTION.

- AUTHORITY APPROVED PLANS/DOCUMENTS
 AUTHORITY APPROVAL CONDITIONS
 RECOMMENDATIONS WITHIN SPECIALIST REPORTS
 INCLUDING VEGETATION MANAGEMENT PLANS

- INCLUDING YEEL AT HOM MANAGEMENT PLANS
 4. AUTHORITY STANDARDS, GUDELINES AND POLICY
 5. DESIGN STANDARD & GUIDELINES (IECA)
 6. PROJECT DRAWINGS, NOTES AND DETAILS (INCLUDING ALL MELIORA CIVIL DRAWINGS)
 7. ENGINEERING SPECIFICATIONS (IF PUBLISHED)

FOR APPROVAL

PROSPERITY CAPITAL PRINCIPLES PL 2270 **EROSION & SEDIMENT CONTROL** DETAILS PLAN MELIORA 11 SHANAHAN PARADE, REDBANK PLAINS SHEET 1 OF 2 C15 01 REVISION 01 ISUUE FOR APPROVAL 17.02.23 SM MB RPEQ No. 21258 DATE: FEB 2023 MAME REV DESCRIPTION


DIAL BEFORE YOU DIG

TYPICAL DIVERSION DRAIN LEVEL SPREADER DETAIL

IECA STANDARD DRAWING REFERENCE - TAKES PRECEDENCE REFER TO IECA STANDARD DRAWING SD-LS01 WHICH SUPERSEDES ALL NOTES AND DETAILS WITHIN THE DETAIL ABOVE


ALL PLANS TO BE READ IN CONJUNCTION WITH ALL INFORMATION AND NOTES ON DRG. No. C01 AND ALL RELEVANT SPECIFICATIONS

DIAL BEFORE YOU DIG

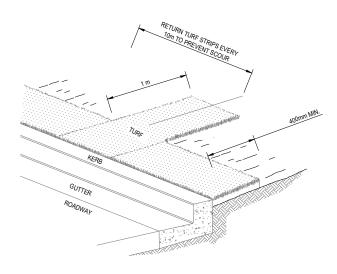

TYPICAL KERBSIDE TURF STRIP DETAIL

IECA STANDARD DRAWING REFERENCE - TAKES PRECEDENCE REFER TO IECA STANDARD DRAWING SD-GFS01 WHICH SUPERSEDES ALL NOTES AND DETAILS WITHIN THE DETAIL ABOVE

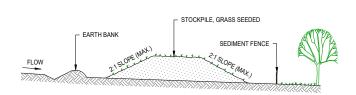

- CONSTRUCTION NOTES

 1. PLACE STOCKPILES MORE THAN 2m (PREFERABLY 5m) FROM EXISTING VEGETATION, CONCENTRATED WATER FLOW, ROADS AND HAZARD AREAS.
- 2. CONSTRUCT ON THE CONTOUR AS LOW, FLAT, ELONGATED MOUNDS.
- 2. CONSTRUCT ON THE CONTOUR AS LOW, FAIL, ECONOMIC INVOIDES.

 3. WHERE THERE IS SUPPLICIENT AREA, TOPSOIL STOCKPILES SHALL BE LESS THAN 2m IN HEIGHT.

 4. WHERE THEY ARE TO BE IN PLACE FOR MORE THAN 10 DAYS, STABILISE FOLLOWING THE APPROVED ESCP OR SWIMP TO REDUCE THE C-FACTOR TO LESS THAN 0.10.

 5. CONSTRUCT EARTH BANKS (IECA STANDARD DRAWING SD-CD01) ON THE UPSLOPE SIDE TO DIVERT WATER AROUND STOCKPILES AND SEDIMENT FENCES (IECA STANDARD DRAWING SD-SF01) 1 TO 2m DOWNSLOPE.

TYPICAL STOCKPILES DETAIL


LAYOUT & NOTES REFERENCE FOR E&SC LAYOUT PLAN REFER DWG № C10.


REFERENCE PRECEDENCE
REFER TO REQUIREMENTS OF THE FOL REFER TO REQUIREMENTS OF THE FOLLOWING MANDATORY REFERENCE DOCUMENTS (IN ORDER OF PRECEDENCE). REQUEST IF NOT RECEIVED DURING TENDER. CONTRACTOR WILL BE LIABLE FOR NON-COMPLIANT CONSTRUCTION. RAISE DISCREPANCIES WITH SUPERINTENDENT PRIOR TO CONSTRUCTION.


- AUTHORITY APPROVED PLANS/DOCUMENTS
 AUTHORITY APPROVAL CONDITIONS
 RECOMMENDATIONS WITHIN SPECIALIST REPORTS INCLUDING VEGETATION MANAGEMENT PLANS
 AUTHORITY STANDARDS, GUIDELINES AND POLICY
 DESIGN STANDARD & GUIDELINES (IECA)
 PROLECT DRAWINGS, NOTES AND DETAILS (INCLUDING ALL MELIORA CIVIL DRAWINGS)
 ENGINEERING SPECIFICATIONS (IF PUBLISHED)

FOR APPROVAL

PROSPERITY CAPITAL PRINCIPLES PL **EROSION & SEDIMENT CONTROL** 2270 **DETAILS PLAN** MELIORA 11 SHANAHAN PARADE, REDBANK PLAINS SHEET 2 OF 2 C16 01 REVISION 01 ISSUE FOR APPROVAL 17.02.23 SM MB manyt REV DESCRIPTION

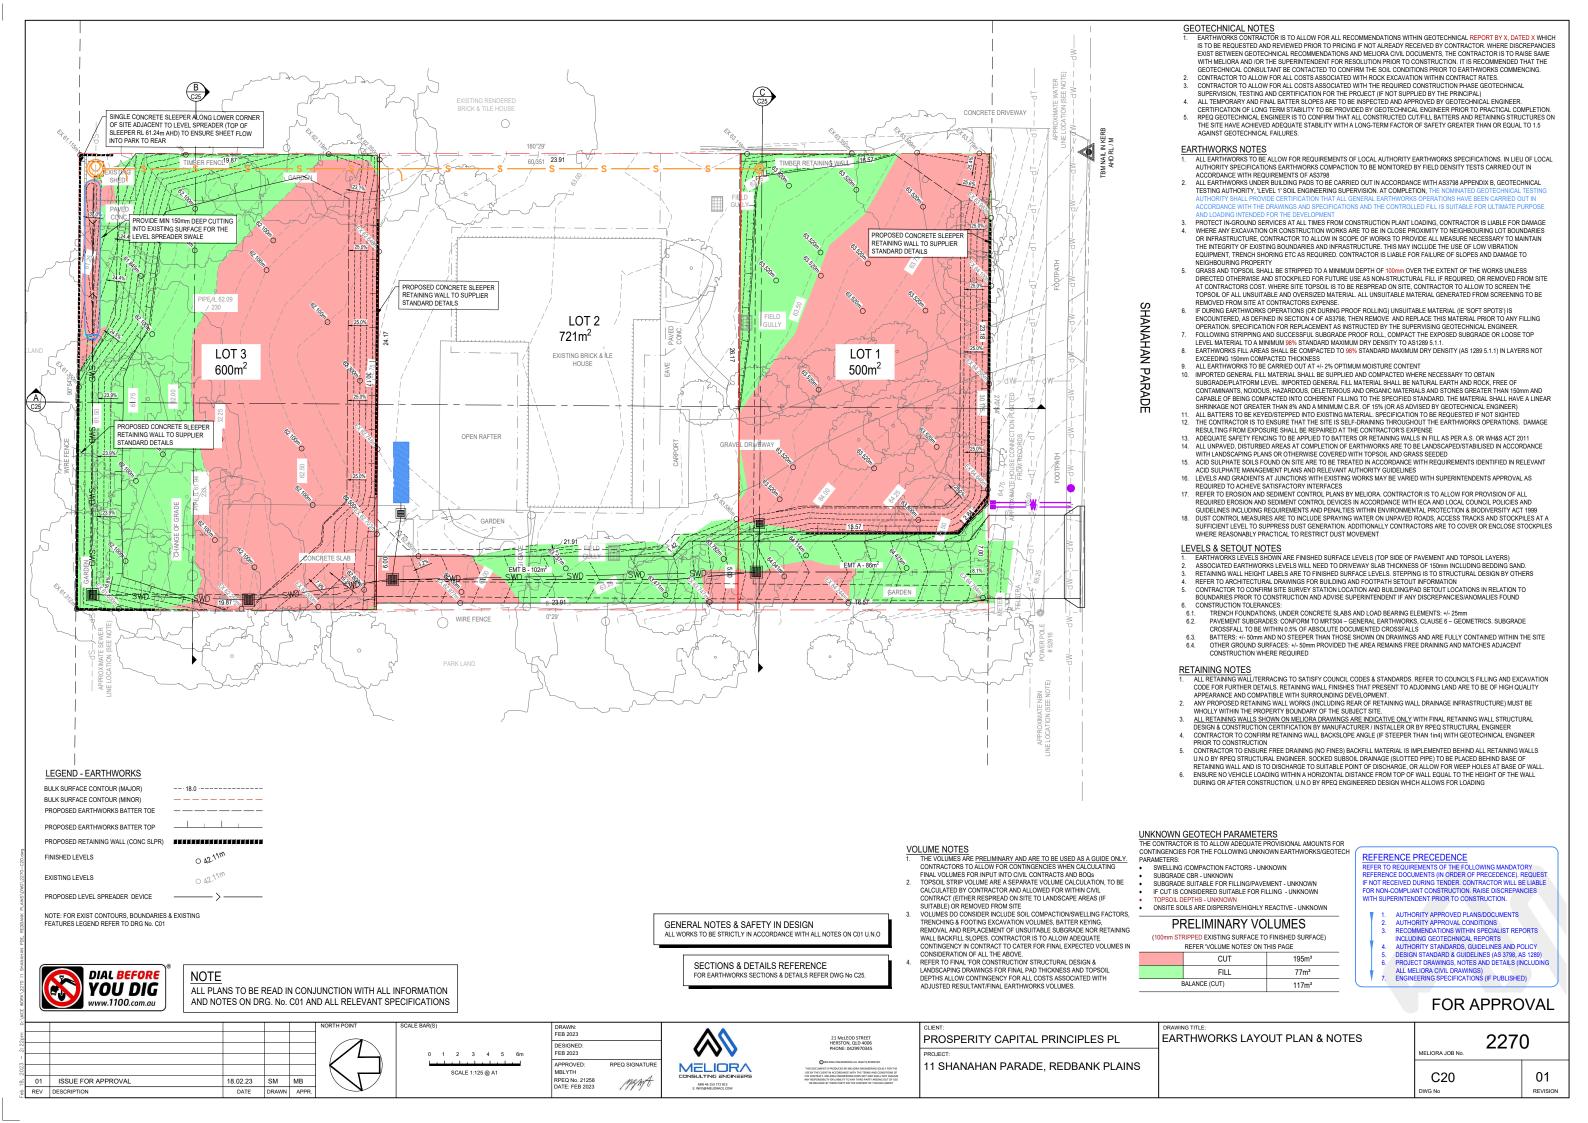

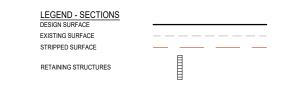

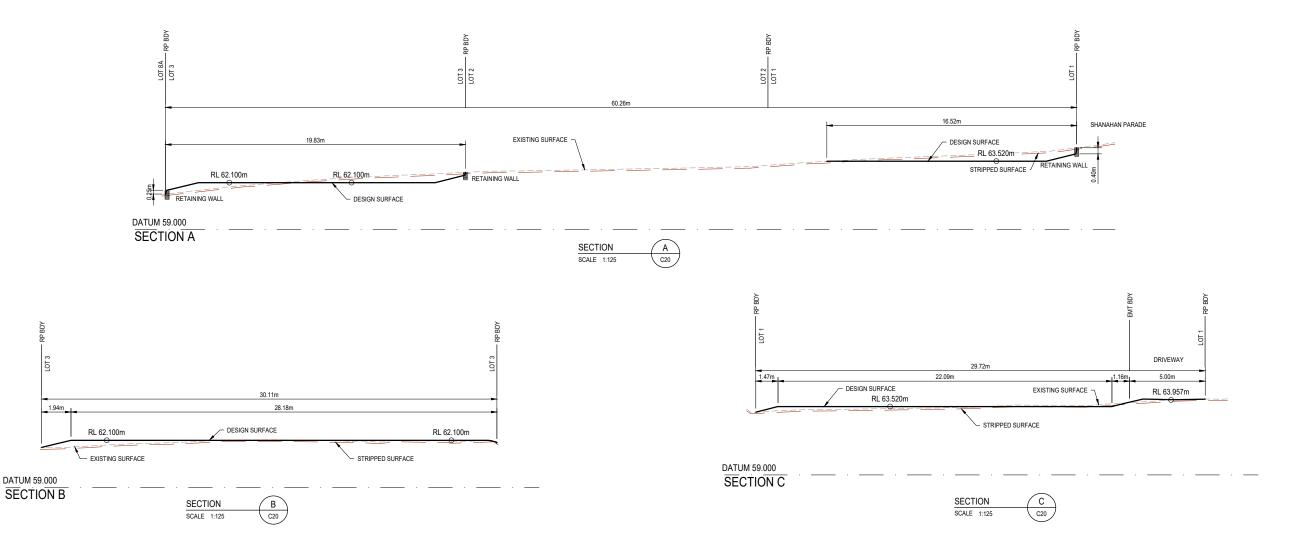

LAYOUT & NOTES REFERENCE FOR EARTHWORKS LAYOUT PLAN REFER DWG No C20.

REFERENCE PRECEDENCE
REFER TO REQUIREMENTS OF THE FOLLOWING MANDATORY
REFERENCE DOCUMENTS (IN ORDER OF PRECEDENCE). REQUEST
IF NOT RECEIVED DURING TENDER. CONTRACTOR WILL BE LIABLE
FOR NON-COMPLIANT CONSTRUCTION. RAISE DISCREPANCIES
WITH SUPERINTENDENT PRIOR TO CONSTRUCTION.

- AUTHORITY APPROVED PLANS/DOCUMENTS
 AUTHORITY APPROVAL CONDITIONS
 RECOMMENDATIONS WITHIN SPECIALIST REPORTS
 INCLUDING GEOTECHNICAL REPORTS
 AUTHORITY STANDARDS, GUIDELINES AND POLICY
 DESIGN STANDARD & GUIDELINES (AS 3798, AS 1289)
 PROJECT DRAWINGS, NOTES AND DETAILS (INCLUDING
 ALL MELIORA CIVIL DRAWINGS)
 ENGINEERING SPECIFICATIONS (IF PUBLISHED)


FOR APPROVAL

DRAWN: FEB 2023 EARTHWORKS SECTIONS 2270 PROSPERITY CAPITAL PRINCIPLES PL 21 McLEOD STREET HERSTON, QLD 4006 PHONE: 0429970345 DESIGNED: FEB 2023 MELIORA JOB No. SCALE 1:125 @ A1 APPROVED: MBLYTH MELIORA CONSULTING ENGINEERS 11 SHANAHAN PARADE, REDBANK PLAINS 01 C25 01 ISSUE FOR APPROVAL 18.02.23 SM MB RPEQ No. 21258 DATE: FEB 2023 MAMA REVISION



DATUM 59.000

NOTE
ALL PLANS TO BE READ IN CONJUNCTION WITH ALL INFORMATION AND NOTES ON DRG. No. C01 AND ALL RELEVANT SPECIFICATIONS

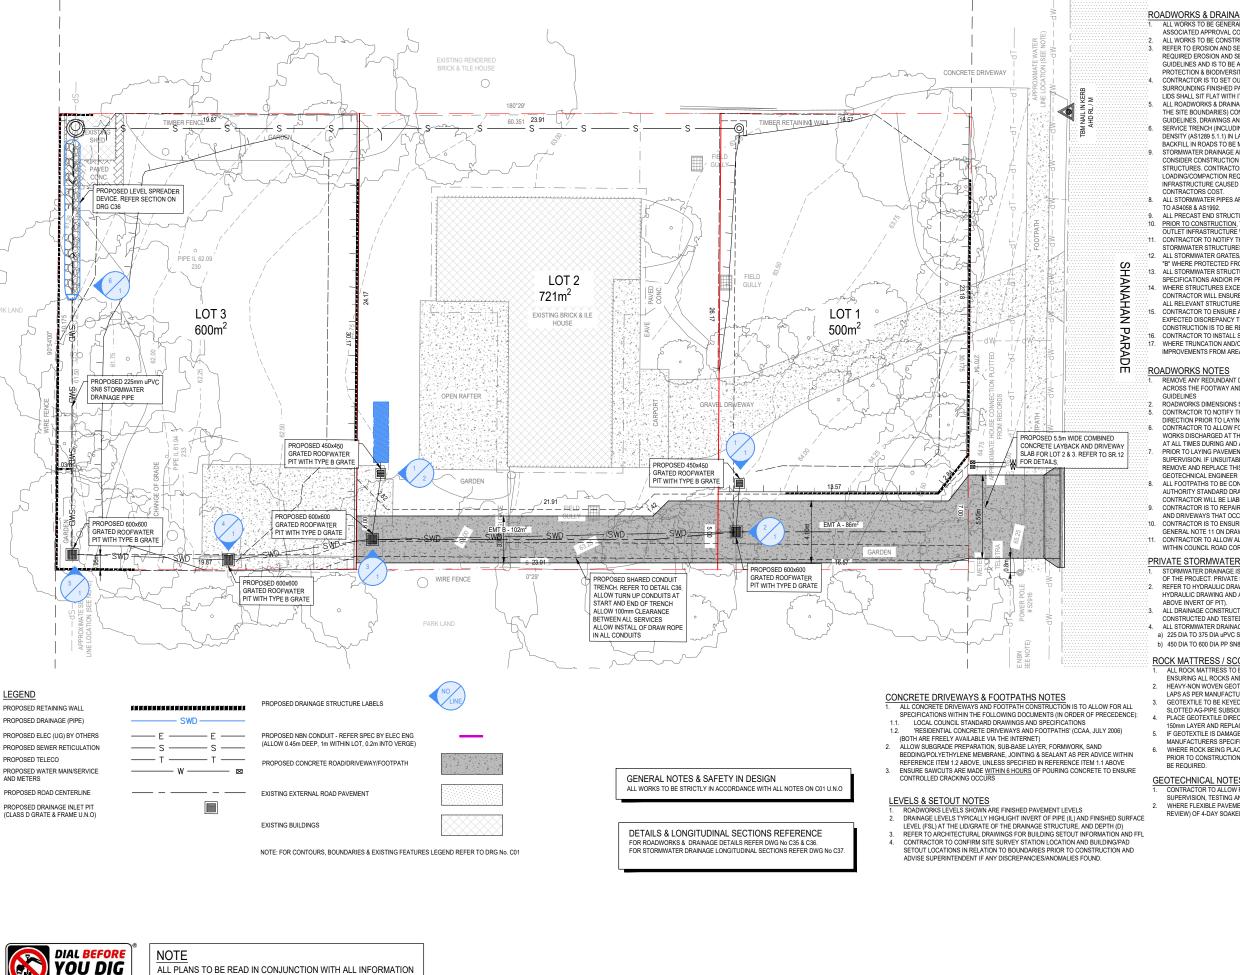

AND NOTES ON DRG. No. C01 AND ALL RELEVANT SPECIFICATIONS

ww.1100.com.au

ROADWORKS & DRAINAGE NOTES

- ALL WORKS TO BE GENERALLY IN ACCORDANCE WITH COUNCIL APPROVED DEVELOPMENT APPLICATION DOCUMENTS AND ASSOCIATED APPROVAL CONDITIONS
 ALL WORKS TO BE CONSTRUCTED IN ACCORDANCE WITH ALL RELEVANT APPROVED MANAGEMENT PLANS.
 REFER TO BEROSION AND SEDIMENT CONTROL PLANS BY MELIORA. CONTRACTOR IS TO ALLOW FOR PROVISION OF ALL REQUIRED EROSION AND SEDIMENT CONTROL DEVICES IN ACCORDANCE WITH IECA AND LOCAL COUNCIL POLICIES AND ${\tt GUIDELINES} \ {\tt AND} \ {\tt IS} \ {\tt TO} \ {\tt BE} \ {\tt AWARE} \ {\tt OF} \ {\tt THE} \ {\tt REQUIREMENTS} \ {\tt AND} \ {\tt PENALTIES} \ {\tt STIPULATED} \ {\tt WITHIN} \ {\tt ENVIRONMENTAL}$ PROTECTION & BIODIVERSITY ACT 1999.
- CONTRACTOR IS TO SET OUT DRAINAGE PIPES & STRUCTURES ON SITE TO CROSS CHECK LEVELS WITH PROPOSED SURROUNDING FINISHED PAVEMENTLANDSCAPING LEVELS PRIOR TO CONSTRUCTION TO ENSURE FLUSH. ALL GRATES AND LIDS SHALL SIT FLAT WITH ITS SURROUND AND NOT BE LOOSE OR MOVE UNDER WHEEL LOADS.

 ALL ROADWORKS & DRAINAGE (EXTERNAL TO SITE BOUNDARIES AND/OR COUNCIL OWNED DRAINAGE PIPES INTERNAL TO
- THE SITE BOUNDARIES) CONSTRUCTION AND TESTING TO BE IN ACCORDANCE WITH IPSWICH CITY COUNCIL DEVELOPMENT GUIDELINES, DRAWINGS AND SPECIFICATIONS.
- SERVICE TRENCH (INCLUDING DRAINAGE) BACKFILL UNDER PAVEMENT TO BE COMPACTED TO 100% STANDARD DRY
- SERVICE TRENCH (INCLUDING DRAINAGE) BACKFILL UNDER PAVEMENT TO BE COMPACTED TO 100% STANDARD DRY DENSITY (AST298 5.1.1) IN LAYERS NOT EXCEEDING 150mm OF CBR 15 MATERIAL OR APPROVED EQUIVALENT. TRENCH BACKFILL IN ROADS TO BE MINIMUM CBR15 MATERIAL UP TO ROAD SUBGRADE LEVEL. STORMWATER DRAINAGE AND STRUCTURES HAVE BEEN DESIGNED FOR OPERATIONAL LOADS ONLY. CONTRACTOR TO CONSIDER CONSTRUCTION LOADINGS AND ENSURE NO EXCESSIVE LOADS ARE PLACED ON STORMWATER DRAINAGE OR STRUCTURES. CONTRACTOR TO REFER TO DRAINAGE PIPE/STRUCTURE MANUFACTURERS FOR CONSTRUCTION LOADING/COMPACTION REQUIREMENTS AND CONTRACTOR WILL BE LIABLE FOR DAMAGE/CRACKING TO DRAINAGE INFRASTRUCTURE CAUSED DURING CONSTRUCTION. DAMAGED INFRASTRUCTURE TO BE REPLACED IMMEDIATELY AT
- ALL STORMWATER PIPES ARE TO BE MANUFACTURED TO RELEVANT AUSTRALIAN STANDARDS INCLUDING BUT NOT LIMITED
- ALL STORMWATER PIPES ARE TO BE MANUFACTURED TO RELEVANT AUSTRALIAN STANDARDS INCLUDING BUT NOT LIMITED TO ASAGBS & AS1992.

 ALL PRECAST END STRUCTURES TO BE CONSTRUCTED WITH REINFORCED CONCRETE END WALL.
 PRIOR TO CONSTRUCTION, THE CONTRACTOR IS TO CONFIRM LOCATION AND LEVEL OF EXISTING STORMWATER DRAINAGE OUTLET INFRASTRUCTURE WHEER PROPOSED DRAINAGE NETWORK CONNECTS TO EXISTING
 CONTRACTOR TO NOTIFY THE SUPERINTENDENT OF ANY UNSUITABLE FOUNDING MATERIAL WITHIN DRAINAGE TRENCH OR
- STORMWATER STRUCTURES AND AWAIT DIRECTION PRIOR TO LAYING OF PIPES.
- ALL STORMWATER GRATES/LIDS WITHIN TRAFFICABLE AREAS TO BE CLASS "D" IN ACCORDANCE WITH AS3996, AND CLASS "B" WHERE PROTECTED FROM VEHICLE LOADING
- B WHITELT HOLDED HOUR DELECTIONS AND ALL STORMWATER STRUCTURES TO BE CONSTRUCTED IN ACCORDANCE WITH LOCAL AUTHORITY STANDARDS AND SPECIFICATIONS AND/OR PROJECT SPECIFICATION.
- SPECIFICATIONS ANDIOR PROJECT SPECIFICATION.
 WHERE STRUCTURES EXCEED 3m (OR THE MAXIMUM DEPTH AS IDENTIFIED WITHIN AUTHORITY STANDARDS) THE
 CONTRACTOR WILL ENSURE AN ADEQUATE RPEQ STRUCTURAL ENGINEERING DESIGN & CERTIFICATION IS SOUGHT FOR
 ALL RELEVANT STRUCTURES FOR RELEVANT LOADING CIRCUMSTANCES PRIOR TO CONSTRUCTION
- ALL RELEVANT STOCK UNES FOR RELEVANT LOADING CIRCUMS IANCES PRIOR TO CONSTRUCTION
 CONTRACTOR TO ENSURE ALL MANHOLE STRUCTURES COMPLY WITH THE DEPTHS SPECIFIED ON THE DRAWINGS, ANY
 EXPECTED DISCREPANCY TO BE RAISED WITH SUPERINTENDENT PRIOR TO CONSTRUCTION. ANY NON CONFORMING
 CONSTRUCTION IS TO BE RECTIFIED AT THE CONTRACTORS EXPENSE
 CONTRACTOR TO INSTALL STEP IRONS WITHIN MANHOLES/FIELD INLETS WHERE REQUIRED BY LOCAL AUTHORITY
 WHERE TRUNCATION ANDIOR ROAD DEDICATION IS PROPOSED, THE CONTRACTOR IS TO ALLOW FOR REMOVAL OF ALL
 IMPROVEMENTS FROM AREA OF DEDICATED ROAD IS PROPOSED AND REINSTATE THE VERGE/FOOTWAY TO COUNCIL CODE.

- ROADWORKS NOTES

 1. REMOVE ANY REDUNDANT DRAINAGE OUTLETS ANDIOR REDUNDANT CROSSOVERS INCLUDING ANY ASSOCIATED PIPEWORK
 ACROSS THE FOOTWAY AND REINSTATE THE KERB AND CHANNEL AND THE FOOTWAY AREA IN ACCORDANCE WITH COUNCIL
- ROADWORKS DIMENSIONS SHOWN ARE TO NOMINAL FACE OF KERB OR EDGE OF PAVEMENT IF NO KERB
- CONTRACTOR TO NOTIFY THE SUPERINTENDENT OF ANY UNSUITABLE FOUNDING MATERIAL AT SUBGRADE AND AWAIT DIRECTION PRIOR TO LAYING PAVEMENT CONTRACTOR TO ALLOW FOR INSTALLATION OF SOCKED PAVEMENT SUBSOIL DRAINAGE ALONG ALL EDGES OF PAVEMENT
- CONTRACTOR TO ALLOW FOR INSTALLATION OF SOCKED PAVEMENT SUBSOIL DRAINAGE. ALONG ALL EDGES OF PAVEMENT WORKS DISCHARGED AT THE LOW POINT TO CIVIL DRAINAGE AND IS TO ENSURE THE PAVEMENT IS ADEQUATELY DRAINED AT ALL TIMES DURING AND AFTER CONSTRUCTION PRIOR TO LAYING PAVEMENTS, ALLOW FOR SUB GRADE PROOF ROLL UNDER GEOTECHNICAL AND CIVIL ENGINEER SUPERVISION. IF UNSUITABLE MATERIAL (IE "SOFT SPOTS") IS ENCOUNTERED, AS DEFINED IN SECTION 4 OF AS3798, THEN REMOVE AND REPLACE THIS MATERIAL TO A DEPTHIEXTENT AND SPECIFICATION AS INSTRUCTED BY THE SUPERVISING
- ALL FOOTPATHS TO BE CONSTRUCTED IN ACCORDANCE WITH ARCHITECTURAL/LANDSCAPING DRAWINGS AND RELEVANT ALL FOOTPATHS TO BE CONSTRUCTED IN ACCORDANCE WITH ARCHITECTURALIZANDSCAPING DRAWNINGS AND RELEVANT AUTHORITY STANDARD BROWNINGS AND SPECIFICATIONS. FOOTPATHS TO BE CONSTRUCTED WITH MAXIMUM 2% CROSSFALL. CONTRACTOR WILL BE LIABLE TO REPLACE NON-COMPLIANT FOOTPATH AT THEIR COST.

 CONTRACTOR IS TO REPAIR ANY DAMAGE TO EXISTING KERB AND CHANNEL, PAVEMENT, DRAINAGE, FENCES, LANDSCAPING AND DRIVEWAYS THAT OCCUR DURING CONSTRUCTION AT THEIR COST.

 CONTRACTOR IS TO ENSURE ALL REQUIRED SERVICE CONDUITS ARE INSTALLED PRIOR TO ROADWORKS, REFER TO CONTRACTOR IS TO ENSURE ALL REQUIRED SERVICE CONDUITS ARE INSTALLED PRIOR TO ROADWORKS, REFER TO
- GENERAL NOTE 11 ON DRAWING CO1 (MELIORA COVER SHEET), CONTRACTOR WILL BE LIABLE FOR REWORK
- CONTRACTOR TO ALLOW ALL COSTS FOR TRAFFIC MANAGEMENT AND WORKS PERMITS FOR ROADWORKS & VERGE WORKS WITHIN COLINCIL ROAD CORRIDOR

PRIVATE STORMWATER DRAINAGE NOTES

- STORMWATER DRAINAGE IS CONSIDERED TO BE PRIVATE WHEN IT IS NOT ADOPTED BY AUTHORITY FOLLOWING COMPLETION OF THE PROJECT. PRIVATE DRAINAGE IS THE RESPONSIBILITY OF THE DEVELOPER/SITE OWNER.

 REFER TO HYDRAULIC DRAWINGS FOR BUILDING, BASEMENT, ROOF AND PODIUM LEVEL DRAINAGE. CONTRACTOR TO REVIEW
- HYDRAULIC DRAWING AND ALLOW FOR CONNECTION STUBS INTO CIVIL PITS WHERE REQUIRED (IL OF STUB TO BE 50mm ABOVE INVERT OF PIT). ALL DRAINAGE CONSTRUCTION (PRIVATELY OWNED DRAINAGE LINES INTERNAL TO THE SITE BOUNDARIES) ARE TO BE
- CONSTRUCTED AND TESTED IN ACCORDANCE WITH RELEVANT AUSTRALIAN STANDARD INCLUDING AS 3500.
 ALL STORMWATER DRAINAGE PIPES INTERNAL TO SITE SHALL BE:
 a) 225 DIA TO 375 DIA UPVC SN8 RUBBER RING JOINTED, BLACKMAX OR APPROVED EQUIVALENT.
- b) 450 DIA TO 600 DIA PP SN8 RUBBER RING JOINTED, BLACKMAX OR APPROVED EQUIVALENT

ROCK MATTRESS / SCOUR PROTECTION NOTES

- ALL ROCK MATTRESS TO BE ANGULAR BOULDERS, ALL VOIDS TO BE FILLED WITH PROGRESSIVELY SMALLER ROCKS ENSURING ALL ROCKS AND BOULDERS ARE FULLY INTERLOCKED.
- HEAVY-NON WOVEN GEOTEXTILE LAYER TO BE PLACED UNDER ALL ROCK MATTRESS, TO BE INSTALLED AND SEWN WITH
- HEAVY-NON WOVEN GEOTEXTILE LAYER TO BE PLACED UNDER ALL ROCK MATTRESS, TO BE INSTALLED AND SEWN WITH LAPS AS PER MANUFACTURERS SPECIFICATION GEOTEXTILE TO BE KEYED-IN BY A 500mm x 500mm TRENCH AT TOP AND TOE OF BATTER, WITH TOP KEY TO FEATURE A SLOTTED AG-PIPE SUBSOIL DRAIN TO DISCHARGE TO SUITABLE OUTLET PLACE GEOTEXTILE DIRECTLY ON COMPACTED FOUNDAMIONISUBGRADE. IF SUBGRADE IS DISPERSIVE SOIL, REMOVE 150mm LAYER AND REPLACE WITH GBR 15 COMPACTED TO 95% SD.
- IF GEOTEXTILE IS DAMAGED DURING CONSTRUCTION, REPAIR ANY DAMAGE USING LAPPED SEWN PATCH AS PER
- MANUFACTURERS SPECIFICATION. WHERE ROCK BEING PLACED ON SLOPES OF MORE THAN 1 in 10 THE ENGINEER AND SUPERINTENDENT TO BE CONSULTED.
- PRIOR TO CONSTRUCTION. GEOTECHNICAL SUBGRADE PROPERTIES ARE TO BE CONFIRMED, AND STONE PITCHING MAY

- GEOTECHNICAL NOTES

 1. CONTRACTOR TO ALLOW FOR ALL COSTS ASSOCIATED WITH ANY REQUIRED CONSTRUCTION PHASE GEOTECHNICAL SUPERVISION, TESTING AND CERTIFICATION FOR THE PROJECT INCLUDING DRAINAGE AND ROADWORKS
- 2. WHERE FLEXIBLE PAVEMENT EXISTS, CONTRACTOR IS TO ALLOW COST AND TIME ASSOCIATED WITH TESTING (AND MELIORA REVIEW) OF 4-DAY SOAKED CBR TESTS AT SUBGRADE LEVEL. PRIOR TO LAYING SUB-BASE LAYERS

REFERENCE PRECEDENCE

REFER TO REQUIREMENTS OF THE FOLLOWING MANDATORY REFERENCE DOCUMENTS (IN ORDER OF PRECEDENCE). REQUEST IF NOT RECEIVED DURING TENDER. CONTRACTOR WILL BE LIABLE FOR NON-COMPLIANT CONSTRUCTION. RAISE DISCREPANCIES WITH SUPERINTENDENT

- AUTHORITY APPROVED PLANS/DOCUMENTS
- AUTHORITY APPROVAL CONDITIONS
 RECOMMENDATIONS WITHIN APPROVED SPECIALIST REPORTS INCLUDING

- STURWING A REPUSE MANAGEMENT, FLOUD, HAFFIE ENGINEERING A REPUSE MANAGEMENT REPORTS AUTHORITY STANDARDS, GUIDELINES AND POLICY DESIGN STANDARD & GUIDELINES (QUDM, AS350), AUSTROADS, MUTCD) PROJECT DRAWINGS, NOTES AND DETAILS (INCLUDING ALL MELIORA CIVIL

- ENGINEERING SPECIFICATIONS (IF PUBLISHED)


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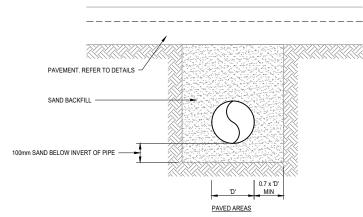
PROSPERITY CAPITAL PRINCIPLES PL ROADWORKS & DRAINAGE 2270 DESIGNED FEB 2023 LAYOUT PLAN 0 1 2 3 4 5 6m

MELIORA 11 SHANAHAN PARADE, REDBANK PLAINS SCALE 1:125 @ A1 C30 01 01 ISSUE FOR APPROVAL 17.02.23 SM MB RPEQ No. 21258 DATE: FEB 2023 MAME REV DESCRIPTION

MINIMUM INTERNAL DIMENSIONS (AT DEPTH) FOR STORMWATER PITS


DEPTH TO	MINIMUM INTERNAL DIMENSIONS mm			
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OUTLET	WIDTH	LENGTH	DIAMETER	
≤600	450	450	600	
>600 ≤900	600	600	900	
>900 ≤1200	600	900	1000	
>1200	900	900	1000	



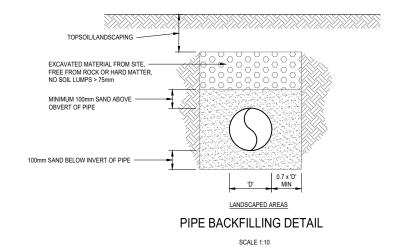

PIPE BACKFILLING DETAIL

SCALE 1:10

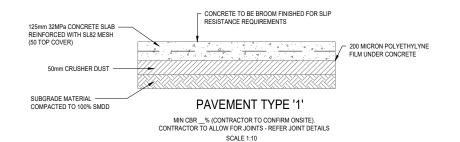

LAYOUT & NOTES REFERENCE FOR ROADWORKS & DRAINAGE LAYOUT PLAN REFER DWG No C30.


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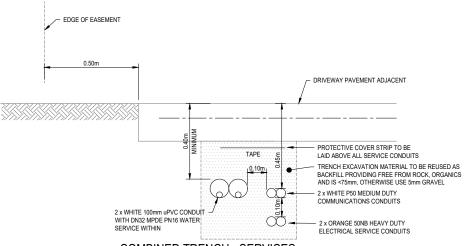
ALL PLANS TO BE READ IN CONJUNCTION WITH ALL INFORMATION AND NOTES ON DRG. No. C01 AND ALL RELEVANT SPECIFICATIONS

FOR APPROVAL

900	NORTH POINT	SCALE BAR(S)	DRAWN: FEB 2023 DESIGNED:		21 McLEOD STREET HERSTON, QLD 4006 PHONE: 0429970345	PROSPERITY CAPITAL PRINCIPLES PL	DRAWING TITLE: ROADWORKS & DRAINAGE DETAILS	2270	o l
£ 1 1 1 1 1 1 1 1 1 1 1 1 1 1 1 1 1 1 1			FEB 2023 APPROVED: RPEQ SIGNATURE MBLYTH	MELIORA CONSULTING ENGINEERS	PITUNE: UH.2997/U345 ©MELIORA ENGINEERING ALL RIGHTS SESSENED THIS DOCUMENT IS PRODUCTED BY MELIORAR ENGINEERING SIZELY FOR THE LISE BY THE CLEARTH ACCORDINATE WHITH BIT ETBERS, AND COMMITTIONS OF	PROJECT: 11 SHANAHAN PARADE, REDBANK PLAINS	SHEET 1 OF 2	MELIORA JOB No.	
			RPEQ No. 21258 DATE: FEB 2023	ABN 46 153 772 813 E: INFO@MEUDRACE.COM	THE CONTROL THE MELITION ENVIRONMENT OF THE OPEN THE OF THE OPEN THE OF THE OPEN THE			C35	REVISION



SECTION L - LEVEL SPREADER ARRANGEMENT

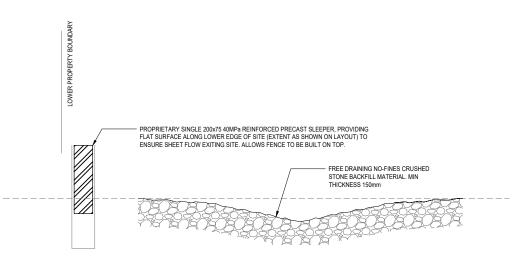

COMBINED TRENCH - SERVICES FOR 2 x REAR LOT, UNDER RC

SCALE 1:10

ELECTRICAL AND COMMUNICATION SERVICE CONDUITS TO BE INSTALLED IN COMPLIANCE WITH ASINZS 3000 (SAA WIRING RULES). ALL CONDUITS TO BE INSTALLED WITH DRAW WIRE AND CAPPED MIN 1 METRE WITHIN LOT BEING SERVICED. TURN UP CONDUITS AT START AND END OF SERVICES TRENCH FOR EASE OF CONNECTION



ALL PLANS TO BE READ IN CONJUNCTION WITH ALL INFORMATION AND NOTES ON DRG. No. C01 AND ALL RELEVANT SPECIFICATIONS

DESIGNED: FEB 2023 APPROVED: MBLYTH RPEQ No. 21258 DATE: FEB 2023

DRAWN: FEB 2023

MELIORA

PROSPERITY CAPITAL PRINCIPLES PL

11 SHANAHAN PARADE, REDBANK PLAINS

ROADWORKS & DRAINAGE DETAILS SHEET 2 OF 2


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01 ISSUE FOR APPROVAL 17.02.23 SM MB REV DESCRIPTION

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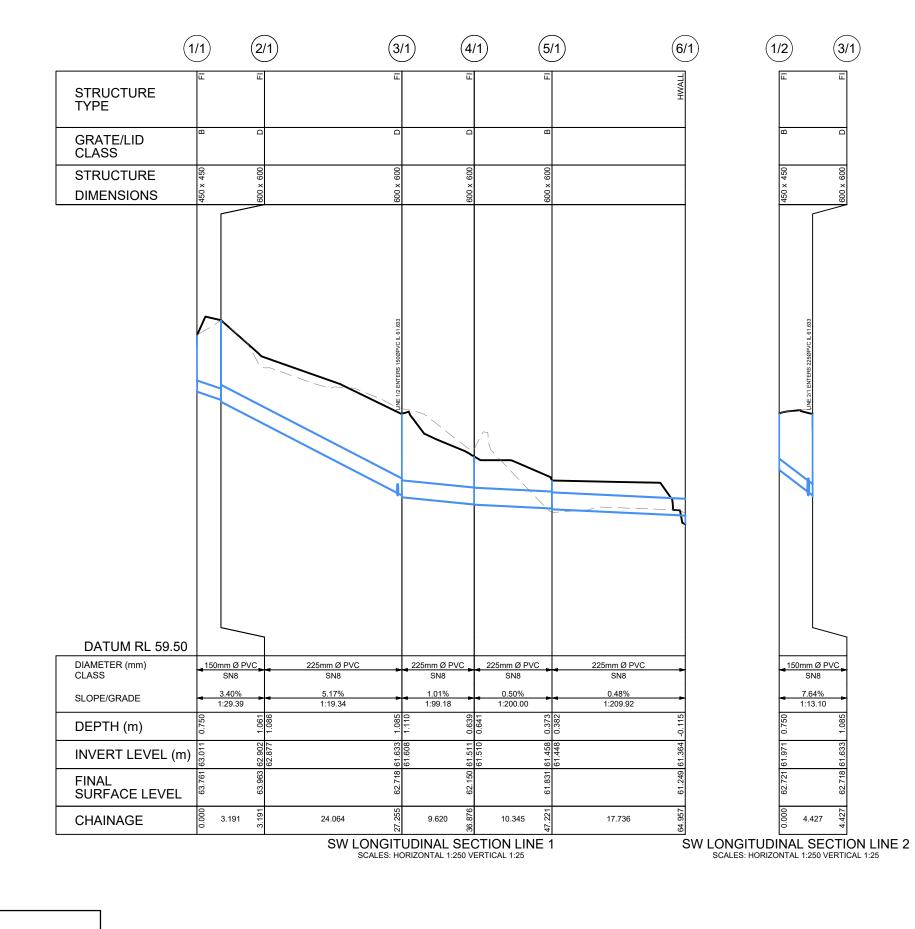
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01 ISSUE FOR APPROVAL

17.02.23 SM MB

01 REVISION C40

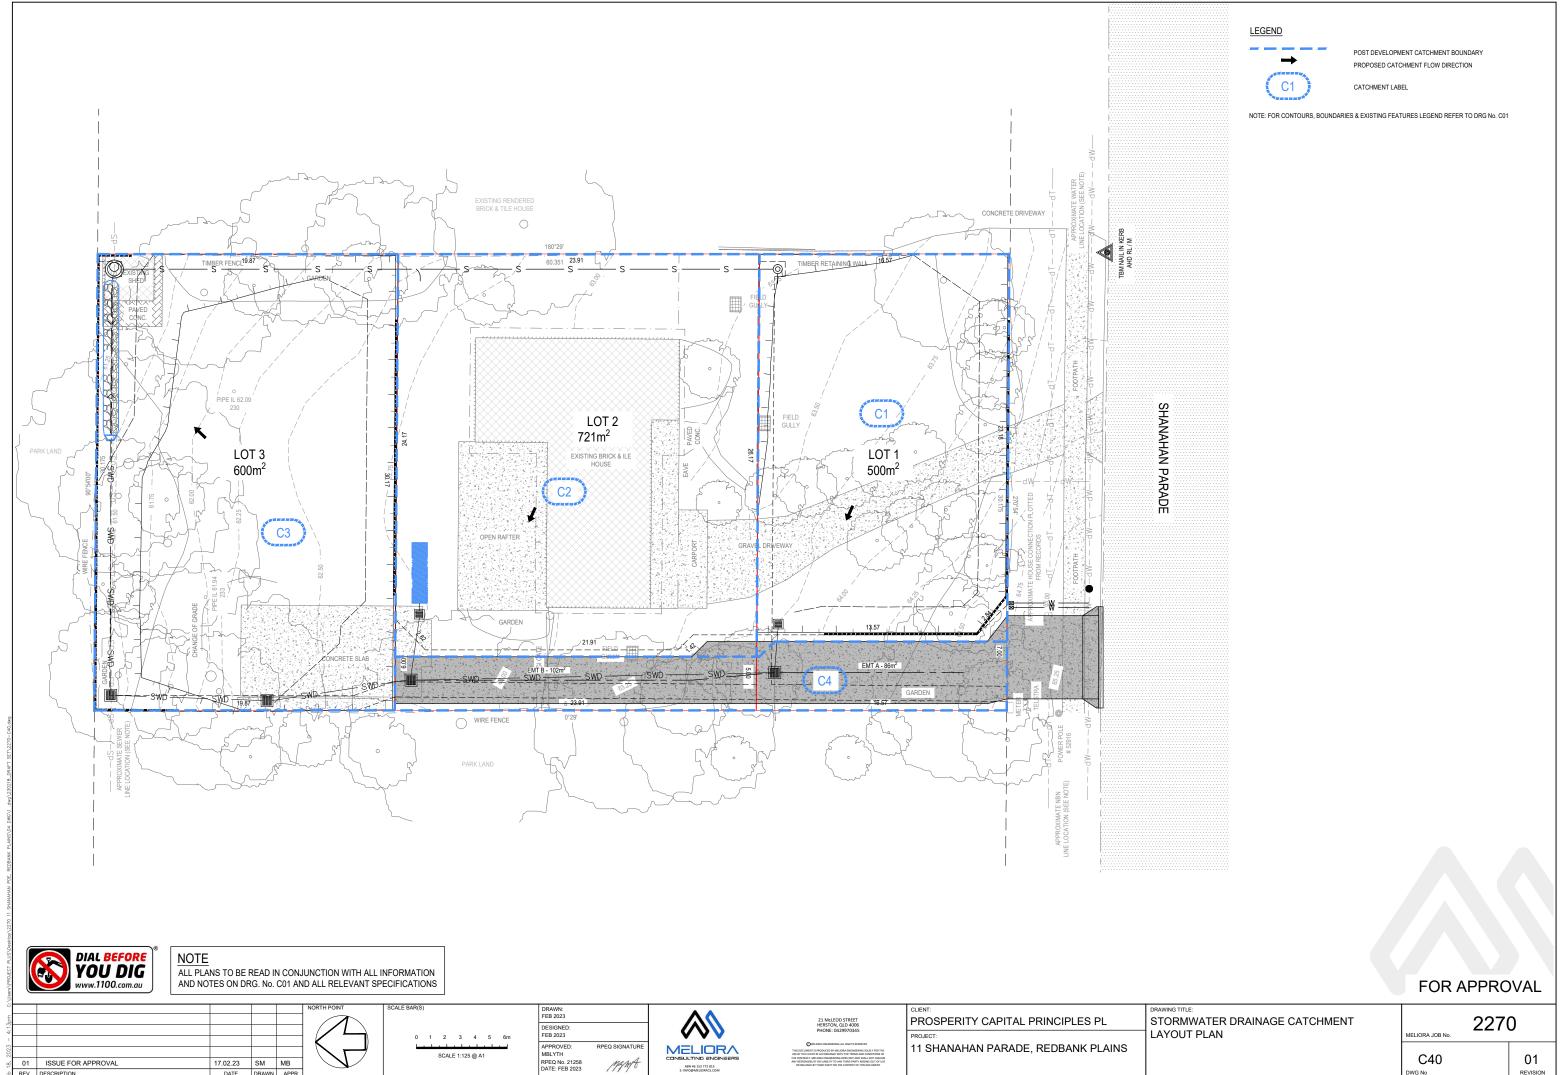

LAYOUT & NOTES REFERENCE FOR ROADWORKS & DRAINAGE LAYOUT PLAN REFER DWG No C30.

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<u>NOTE</u>

ALL PLANS TO BE READ IN CONJUNCTION WITH ALL INFORMATION AND NOTES ON DRG. No. C01 AND ALL RELEVANT SPECIFICATIONS

FOR APPROVAL

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	RPEQ No. 21258 DATE: FEB 2023



21 MCLEOD STREET HERSTON, QLD 4006 PHONE: 0429970345
OMELIOPA ENGINEERING ALL RIGHTS RESERVED
THIS DOCUMENT IS PRODUCED BY MELIORA ENGINEERING SOLELY FOR THE USE BY THE CLIENT IN ACCORDANCE WITH THE TERMS AND CONDITIONS OF THE CONTRACT, MELIORA ENGINEERING DOES NOT AND SHALL NOT ASSUME
ANY RESPONSIBILITY OR LIABILITY TO ANY THIRD PARTY ARISING OUT OF USE OR RELIANCE BY THIRD PARTY ON THE CONTENT OF THIS DOCUMENT

CLIENT:
PROSPERITY CAPITAL PRINCIPLES PL
PROJECT:
11 SHANAHAN PARADE, REDBANK PLAINS

AWING TITLE:	
TORMWATER DRAINAGE I	LONGITUDINAL
ECTION	

JDINAL	MELIORA JOB No.	2270

C41 01

DWG No REVISION

SEWER & WATER CONNECTION WORKS

11 SHANAHAN PARADE, REDBANK PLAINS, PNT # 23-PNT-64086

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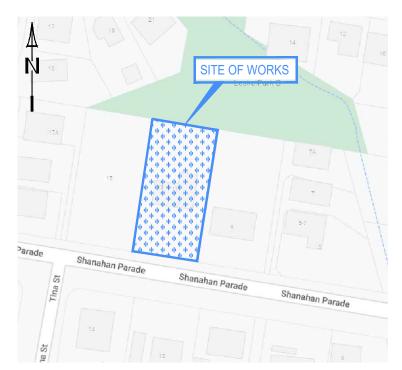
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LOCALITY PLAN

EXTRACTED FROM GOOGLE MAPS @ 2020

LOT DATA	
27	RP 132756

REFER TO SURVEY PLAN BY XXXXX FOR REFERENCE PSM TO BE USED AS REFERENCE FOR ALL SETOUT INFORMATION DURING CONSTRUCTION. CONTRACTOR TO CONFIRM SURVEY SETOUT REFERENCE WITH REGISTERED SURVEYOR PRIOR TO CONSTRUCTION. ALL LEVELS TO AUSTRALIAN HEIGHT DATUM (AHD). GRID COORDINATE SYSTEM AS SPECIFICIED BY SURVEYOR.

MELIORA ENGINEERING ACCEPTS NO RESPONSIBILITY FOR THE ACCURACY OF EXISTING UNDERGROUND SERVICES WHICH ARE PLOTTED FROM AUTHORITY RECORDS BY THE SURVEYOR, DOCUMENTED DESIGNS MAY BE SUBJECT TO ONGOING CHANGES UNTIL RECEIPT AND REVIEW OF ALL 'LEVEL 1' EXISTING SERVICE LOCATION RESULTS ALONG FULL LENGTH OF PROPOSED MAIN ALIGNMENTS. MELIORA WILL NOT BE HELD LIABLE FOR COST INCREASES OR TIME EXTENSION RESULTING FROM NECESSARY DESIGN CHANGES TO ACHIEVE AUTHORITY CODE COMPLIANCE

WORKS DRAWING SCHEDULE	
DRAWING No.	DRAWING TITLE
C50	SEWER & WATER COVER SHEET, LOCALITY PLAN & MISC NOTES
C51	SEWER & WATER GENERAL NOTES
C52	SEWER & WATER TECHNICAL NOTES
C53	SEWER LAYOUT PLAN
C54	SEWER LONGITUDINAL SECTION & DETAILS
C55	WATER LAYOUT PLAN

ALL PLANS TO BE READ IN CONJUNCTION WITH INFORMATION AND NOTES ON DRG. No. C01 & C50 AND ALL RELEVANT SPECIFICATIONS

GENERAL LEGEND

DETAIL CALLOUT & REFERENCE

DESIGN/FINISHED SURFACE CONTOURS EXISTING SURFACE CONTOURS

BOUNDARIES LEGEND

PROPOSED LOT BOUNDARIES PROPOSED EASEMENT

EXISTING FEATURES LEGEND

EXISTING PROPERTY BOUNDARY EXISTING BOUNDARY ADJACENT EXISTING EASEMENT CONTOURS EXISTING MAJOR

CONTOURS EXISTING MINOR EARTHWORKS EXISTING BATTER TOE EARTHWORKS EXISTING BATTER TOP BUILDING EXISTING

BUILDING EXISTING ROOF/EAVE ROAD EXISTING KERB

ROAD EXISTING CENTERLINE

COMMUNICATIONS EXISTING DRAINAGE EXISTING CENTERLINE DRAINAGE EXISTING DBYD

ELECTRICAL EXISTING OVERHEAD ELECTRICAL EXISTING LINDERGROUND ELECTRICAL EXISTING CENTERLINE DBYD

GAS EXISTING CENTERLINE DBYD SEWER EXISTING CENTERLINE

TELECOMMUNICATIONS EXISTING

GAS EXISTING

SEWER EXISTING RISING MAIN SEWER EXISTING CENTERLINE DBYD SEWER RISING MAIN EXISTING CENTERLINE DBYD — — — dSRM— — — dSRM—

TELECOMMUNICATIONS EXISTING CENTERLINE DBYD --dT--dT--dTWATER EXISTING CENTERLINE - w - - - w - - -

WATER EXISTING CENTERLINE DBYD ABANDONED SERVICES EXISTING RETAINING WALL - BOULDER EXISTING RETAINING WALL - BLOCK

EARTHWORKS EXISTING DRAIN EARTHWORKS EXISTING DRAIN CONCRETE

EXISTING VEGETATION

GENERAL NOTES

- ALL WORKS TO BE CARRIED OUT STRICTLY IN ACCORDANCE WITH THE WATER APPROVAL CONDITIONS, CURRENT SEQWISAA/UU (AND OTHER RELEVANT AUTHORITY) GUIDELINES AND STANDARD DRAWINGS UNLESS DIRECTED
- A LEGIBLE COPY OF THE WATER APPROVAL AND DOCUMENTS (INCLUDING CONDITIONS) MUST BE MAINTAINED AND KEPT ON SITE FOR INSPECTION BY SITE WORKERS AND UU OFFICERS & ENDORSED CONSULTANTS AS REQUIRED
- REFER TO MANDATORY REFERENCE NOTES ON THIS PAGE REFER TO ARCHITECTURAL, HYDRAULIC, MECHANICAL AND ELECTRICAL DRAWINGS FOR ADDITIONAL SITE SERVICES TO BE

- REFER TO ARCHITECTURAL, HYDRAULIC, MECHANICAL AND ELECTRICAL DRAWINGS FOR ADDITIONAL SITE SERVICES TO BE CO-ORDINATED WITH AND CONSIDERED DURING CONSTRUCTION OF CIVIL WORK THE DEVELOPER IS TO NOMINATE THE SUPERINTENDENT FOR THE WORKS AND NOTIFY ALL RELEVANT PARTIES PRIOR TO COMMENCEMENT OF CONSTRUCTION ALL DIMENSIONS ON THE DRAWINGS ARE IN METRES UNLESS SHOWN OTHERWISE. DO NOT SCALE OFF THESE DRAWINGS. IF IN DOUBT ASK SUPERINTENDENT FOR CLARIFICATION. IT IS THE CONTRACTOR'S RESPONSIBILITY TO LOCATE ALL EXISTING SERVICES ON SITE PRIOR TO CONSTRUCTION AND LAYING OF ANY SERVICES AND ADVISE THE SUPERINTENDENT OF ANY DIFFERENCES FROM THE DRAWINGS. ANY DAMAGE TO EXCHANGE SERVICES WILL BE DEPONSIBILITY OF THE SUPERINTENDENT OF ANY DIFFERENCES FROM THE DRAWINGS. ANY DAMAGE TO EXCHANGE SERVICES WILL BE DEPONSIBLED ATTHE CONTRACTORS OFCO.
- TO EXISTING SERVICES WILL BE REPAIRED AT THE CONTRACTORS COST.

 ALL SETTING OUT IS THE RESPONSIBILITY OF THE CONTRACTOR PRIOR TO WORKS COMMENCING ON SITE. THE
 SUPPERINTENDENT'S SURVEYOR SHALL PEG ALL ALLOTMENT BOUNDARIES, PROVIDE CO-ORDINATE INFORMATION TO
 THESE PEGS AND PLACE BENCH MARKS. THE CONTRACTOR SHALL SET OUT THE WORKS FROM AND MAINTAIN THESE
- WORKS SHALL BE PROGRAMMED SO AS NOT TO DISTURB NEARBY HOUSEHOLDERS EITHER BY DUST, NOISE, FLOODING OR DISCONNECTION OF SERVICES. (FOR MARKETING REASONS IT IS ESSENTIAL THE SITE IS KEPT IN A TIDY STATE EVEN DURING CONSTRUCTION. THE CONTRACTOR SHALL ALLOW ALL COSTS TO CLEAN-UP THE SITE INCLUDING REMOVAL OF
- DURING CONSTRUCTION. THE CONTRACTOR SHALL ALLOW ALL COSTS TO CLEAN-UP THE SITE INCLUDING REMOVAL OF RUBBISH AND EXCESS SOIL, STACKING OF LOOSE PEPES AND GRADING OF DISTURBED AREAS WEEKLY).

 10. UNDERTAKE ACTIVITIES ASSOCIATED WITH THE OPERATION OF THE USE ONLY BETWEEN THE HOURS OF 6.30am TO 4.30pm MONDAY TO FRIDAY UNLESS STATED OTHERWISE IN THE DEVELOPMENT CONDITIONS.

 11. SURVEY BENCHMARKS ARE TO BE CONFIRMED ONSITE PRIOR TO CONSTRUCTION AND USED AS REFERENCE FOR ALL CONSTRUCTION SETOUT AND PERMANENT SURVEY MARKS ARE TO BE INSTALLED AS PER COUNCIL STANDARDS.

 12. OBTAIN NECESSARY PERMITS AND APPROVALS FROM RELEVANT AUTHORITIES BEFORE COMMENCING WORK ON SITE.
- NOTIFY RELEVANT SERVICE AUTHORITIES BEFORE COMMENCING WORK ON SITE
- NOTIFY RELEVANT SERVICE AUTHORTIES BEFORE COMMENCING WORK ON SITE.

 13. THESE DRAWINGS DO NOT DETAIL TEMPORARY WORKS, CONSTRUCTION METHODS AND TEMPORARY WORKS ARE THE RESPONSIBILITY OF THE CONTRACTOR.

 14. REGARDLESS OF DRAWING ISSUE STATUS, DOCUMENTED DESIGNS MAY BE SUBJECT TO ONGOING CHANGES UNTIL RECEIPT AND REVIEW OF ALL 'LEVEL I'E XISTING SERVICE LOCATION RESULTS ALONG FULL LENGTH OF PROPOSED MAIN ALIGNMENTS. MELIORA WILL NOT BE HELD LIABLE FOR COST INCREASES OR TIME EXTENSION RESULTING FROM NECESSARY DESIGN CHANGES TO ACHIEVE AUTHORITY CODE COMPLIANCE.

MANDATORY REFERENCE DOCUMENTATION

ALL WORKS TO BE CARRIED OUT STRICTLY IN ACCORDANCE WITH THE WATER APPROVAL CONDITIONS, CURRENT SEQ/WSAA/UU (AND OTHER RELEVANT AUTHORITY) GUIDELINES AND STANDARD DRAWINGS UNLESS DIRECTED OTHERWISE. ALL RELEVANT AUTHORITY APPROVALS AND CONDITIONS ARE TO BE REVIEWED (AND REQUESTED IF NOT ALREADY RECEIVED) BY CONTRACTOR PRIOR TO CONSTRUCTION.

READ THESE DRAWINGS IN CONJUNCTION WITH ARCHITECTURAL AND OTHER ENGINEERING DRAWING. SPECIFICATIONS AND WITH ALL OTHER WRITTEN INSTRUCTIONS ISSUED, REFER TO ARCHITECTURAL DRAWINGS FOR SETTING OUT AND DETAIL DIMENSIONS. IN CASE OF DISCREPANCY, PRECEDENCE IS GIVEN TO SPECIFICATION, NOTES THEN DRAWINGS, REFER DISCREPANCIES TO SUPERINTENDENT FOR RESOLUTION BEFORE PROCEEDING WITH WORK

- FURTHER, ALL WORKS TO BE CARRIED OUT IN ACCORDANCE WITH
 1. UU & COUNCIL (LOCAL AUTHORITY) GUIDELINES, PLANNING SCHEME POLICIES (PSPs), SPECIFICATIONS AND STANDARD
- SOUTH EAST QUEENSLAND WATER SUPPLY AND SEWERAGE DESIGN AND
- CONSTRUCTION CODE (OR THE SEQ CODE)
- CONSTRUCTION CODE (OR THE SEQ CODE)
 RELEVANT LEGISLATION INCLUDING (BUT NOT LIMITED TO):

 WORK HEALTH & SAFETY ACT 2011

 ENVIRONMENTAL PROTECTION & BIODIVERSITY ACT 1999

 BIOSECURITY ACT 2015. REFER TO WWW.DAF-QLD.GOV.AU

 SUSTAINABLE PLANNING ACT 1999

 PRESIDANT AUSTRAL MAR CATADRADED ENVILLING (BUT NOT LIMITED AUSTRAL MARCH NOT LIMITED AUSTRAL MARCH NOT LIMITED.)
- RELEVANT AUSTRALIAN STANDARDS INCLUDING (BUT NOT LIMITED TO):
- AS3500.3-2018 (PLUMBING & DRAINAGE)
- AS2865-2009 (CONFINED SPACES)

- 4.2. A\$2865-2009 (CONFINED SPACES)
 4.3. A\$3798-2007 (EARTHVORKS)
 4.4. A\$INZ\$ 2890.1-2004 (PARKING FACILITIES)
 4.5. A\$1742.3-2019 (SIGNAGE & LINE MARKING) SS BY MUTCD
 4.6. A\$409.2-2005 (PAVEMENT MARKING MATERIALS)
 6. INTERNATIONAL EROSION CONTROL AUTHORITY (IECA) & STANDARD DRAWINGS

URBAN UTILITIES

THIRD PARTY CERTIFICATION SCHEME ENDORSED CONSULTANT (PLANS SUBMITTED ARE TO URBAN UTILITIES' STANDARDS AND SATISFY THE WATER APPROVAL CONDITIONS)

ENDORSED CONSULTANT: DMC QLD CONSULTING PTY LTD

RPEQ NAME: DIANA CAMPBELL - 4945

RPEQ SIGNATURE:

RPEO CONTACT DETAILS: 07 3881 2350



REFERENCE PRECEDENCE

EFFER TO REQUIREMENTS OF THE FOLLOWING MANDATORY REFERENCE DOCUMENTS (IN IRDER OF PRECEDENCE). REQUEST IF NOT RECEIVED DURING TENDER. CONTRACTOR WILL BI IABLE FOR NON-COMPLIANT CONSTRUCTION. RAISE DISCREPANCIES WITH SUPERINTENDENT

- WATER AUTHORITY APPROVED PLANS/DOCUMENTS
 WATER AUTHORITY APPROVAL CONDITIONS
 WATER AUTHORITY STANDARDS, GUIDELINES AND POLICY
 DESIGN STANDARD & GUIDELINES (SEQ CODE, WSAA)
 PROJECT DRAWINGS, NOTES AND DETAILS

FOR CONSTRUCTION

17.02.23 SM MB ISSUE FOR CONSTRUCTION

DIAL BEFORE YOU DIG





PO BOX 694 DI IRPFNGARY, QLD 4500 11 SHANAHAN PARADE, REDBANK PLAINS

PROSPERITY CAPITAL PRINCIPLES PL

SEWER & WATER COVER SHEET.

LOCALITY PLAN & MISC NOTES

2270

C50

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UU GENERAL NOTES

- ALL WORKS MUST BE EXECUTED STRICTLY IN ACCORDANCE WITH THE CURRENT SEQ WATER SUPPLY AND SEWERAGE DESIGN & CONSTRUCTION CODE STANDARDS AND SPECIFICATIONS WHICH TAKE PRECEDENCE OVER (AND SUPERSEDE) ALL NOTES AND DETAILS ON MELIORA PLANS. IT IS EXPECTED THAT THE CONTRACTOR HAS ACCESS TO ALL RELEVANT CODES AND STANDARDS. HAS THOROLIGHLY REVIEWED ALL REQUIREMENTS AND HAS EXPERIENCE COMPLETING THE SCOPE OF WORKS WITHIN U
- COVERAGE AREA
 CONTRACTOR TO ENSURE ALL THE MATERIALS USED FOR THIS WORK ARE TO COMPLY WITH (AND
 OBTAINED FROM THE APPROVED SUPPLIERS) AS PER THE CURRENT SEQ CIVIL IPAM LIST AS AVAILABLE FROM UU WEBSITE
- UNLESS SPECIFIED OTHERWISE WITHIN RELEVANT SEQ D&C CODE OR WSAA CODES ALL MATERIALS AND WORK SHALL COMPLY WITH THE RELEVANT AUSTRALIAN STANDARDS
- THE CONSTRUCTION OF THE WATER RETICULATION WORK MUST BE SUPERVISED BY AN ENGINEER THE CONSTRUCTION OF THE WAITER RETIDUCATION WORK MOST BE SUPERVISED BY AN ENGINEER WHO HAS RELEVANT REP REGISTRATION. WORKS NOT COMPLYING WITH THIS REQUIREMENT WILL NOT BE PERMITTED TO CONNECT INTO URBAN UTILITIES'S RETICULATION SYSTEM ONLY UIU PRESONNEL OR UIU PROVIDERS MUIST OPERATE THE EXISTING WATER NETWORK ALL WORK SHALL COMPLY WITH THE REQUIREMENTS OF THE QUEENSLAND WORK HEALTH AND
- SAFETY ACT. CONTACT THE DIVISION OF WORK HEALTH AND SAFETY FOR INFORMATION. PHONE: 1300
- HANDLING OF ASBESTOS CEMENT PIPES SHALL BE CARRIED OUT IN ACCORDANCE WITH WORKPLACE HEALTH AND SAFETY (WH&S) ACT 2011, THE WH&S QUEENSLAND CODE OF PRACTICE AND UU SWMS 10
- CONTRACTOR TO TAKE APPROPRIATE ACTION TO PROTECT AND MAINTAIN UU'S AND OTHER
- CONTRACTOR TO THE APPROPRIATE ACTION TO PROTECT AND MAINTAIN OURS AND OTHER AUTHORITIES! EXISTING SERVICES
 IN THE EVENT OF A BREAKAGE OR ANY OTHER EMERGENCY RELATING TO A UIL ASSET PHONE 13 23 64 IMMEDIATELY AND REPORT TO UIL CONTRACTOR WILL BE LIABLE FOR NOT COMPLYING RESTORE ALL SURFACES TO MATCH PRE-EXISTING SURFACES UNLESS NOTED OTHERWISE.
- REMOVE AND REINSTATE OBJECTS ALONG LINE OF CONSTRUCTION SUCH AS SIGNS, FENCES, ETC BENCH MARK AND LEVELS TO AHD
- ALL DIMENSIONS ARE IN METRES UNLESS OTHERWISE SPECIFIED.

- POLYETHYLENE PIPES (PE):

 PE1 PEIS THE PREFERRED MATERIAL OF CHOICE OF UU AND SHOULD BE USED FOR SEWER AND WATER UNLESS OTHERWISE STATED. ALL PE PIPES AND FITTINGS SHALL BE MATERIAL GRADE PE100 PE2 GRAVITY SEWER PIPES SHALL BE PE100 SDR21 U.N.O. WHERE PIPE CLASSIFICATION IS NOT SPECIFIED CONSULT WITH DESIGN CONSULTANT AND UU
- CONSOLT WITH DESIGN CONSOLTANT AND GO THE CLASS OF PE SEWERS WITH SECONDARY PROTECTION (I.E. ENVELOPED OR CONCRETE ENCASED) IS TO BE MINIMUM OF ONE SIZE UP TO MAINTAIN NOMINAL BORE, AND INCREASED SDR.
- PE4 PRESSURISED MAINS TO BE A MINIMUM CLASS PN16. WHERE PIPE CLASSIFICATION IS NOT SPECIFIED CONSULT WITH DESIGN CONSULTANT AND UU
- PE PIPE COLOUR SHALL BE:
- PED PER PIPE CUDIN SHALL BE:

 DRINKING WATER: EXTERNAL: BLUE (SOLID OR STRIPED IS ACCEPTABLE)

 GRAVITY SEWERS: EXTERNAL: LIGHT GREY (SOLID OR STRIPED IS ACCEPTABLE) INTERNAL:
 WHITE OR LIGHT COLOURED (COMPULSORY)

 PEG

 ALL PE PIPES TO BE BUTT WELDEDIELECTRO FUSION FUSED UNLESS NOTED OTHERWISE
- PRE-CHLORINATED PIPES AND FITTINGS MUST BE USED WHERE INDICATED.
- PER PERIPES WITH CRACKS SCORES OR SCRATCHES DEEPER THAN 10% OF THE WALL THICKNESS SHALL
- DE PIPE MAY BE COLD BENT TO MAXIMUM RADIUS AS PER POP 202, STAKES OR OTHER SOURCES OF POINT LOADS SHALL NOT BE USED TO ASSIST IN BENDING THE PIPE.

- PE WELDING NOTES:
 PW1 PE WELDING MUST ONLY BE CARRIED OUT BY CERTIFIED PERSONS;
 (A) IN ACCORDANCE WITH PARTEC REQUIREMENTS AND
 (B) WHO HAS SUCCESSFULLY CARRIED OUT PREVIOUS PE PRESSURE PIPELINE WELDING PROJECTS. PW2 FUSION BUTT-WELDED JOINTS SHALL BE MADE IN ACCORDANCE WITH WSA 01 - 2004; AS2033, AS2566.2
- AND THE PE PIPE MANUFACTURER'S REQUIREMENTS AND RECOMMENDATIONS. PW3 JOINTS SHALL ONLY BE MADE RETWEEN PIPE MATERIALS OF THE SAME GRADE AS DEFINED IN AS4130
- PILOT WELDS SHALL BE MADE AND TESTED FOR ANY PROPOSED JOINTS BETWEEN PIPES FROM DIFFERENT MANIJEACTURERS
- FUSION BUTT-WELDED JOINTS SHALL ACHIEVE AT LEAST 90% OF THE TENSILE STRENGTH OF THE PARENT PIPE. INTERNAL WELD BEADS SHALL NOT BE REMOVED.
 ALL WELDING SHALL BE PERFORMED UNDER CONTROLLED ENVIRONMENTAL CONDITIONS. FIELD
- WELDING SHALL BE CARRIED OUT IN SHELTERS TO PREVENT DUST AND WATER CONTAMINATION SHELTERS SHALL REMAIN IN PLACE UNTIL COMPLETION OF THE JOINT COOLING PERIOD. PIPE ENDS
- SHELTERS SHALL REMAIN IN PLACE UNTIL COMPLETION OF THE JOINT COOLING PERIOD. PIPE ENDS SHALL BE BLOCKED OF FT O PREVENT WIND CHILL AND DIRT CONTAMINATION. WELDING MACHINES USING HAND WOUND CARRIAGES WITHOUT PRESSURE GAUGES SHALL NOT BE USED. AT ALL TIMES THAT WELDING IS IN PROGRESS, THE WELDER SHALL HAVE AVAILABLE A HAND-HELD TEMPERATURE SENSING DEVICE CAPABLE OF CHECKING THE TEMPERATURE OF THE HEATER PLATE AT THE CIRCUMFERENCE OF THE WELD.

ENVIRONMENTAL NOTES

ENVIRONMENTAL MANAGEMENT

- CONTACT LOCAL COUNCIL PRIOR TO CONSTRUCTION FOR APPROVAL TO REMOVE OR REPLACE EXISTING TREES
- ALL TREES AND SHRUBS THAT ARE TO BE RETAINED MUST BE PROTECTED FROM DAMAGE AS
- NO TREE SHALL BE LOPPED OR REMOVED WITHOUT THE WRITTEN PERMISSION OF THE LOCAL
- ANY TREE LOPPING REQUIRED SHOULD BE UNDERTAKEN BY AN APPROVED ARBORIS PIPELINES ADJACENT TO SIGNIFICANT TREES MUST BE INSTALLED BY BORING OR DIRECTIONAL DRILLING UNLESS OTHERWISE
- AGREED BY UU AND LOCAL COUNCIL FOR TRENCH INSTALLATIONS TREE ROOTS MUST BE EXPOSED BY HAND EXCAVATION. TREE COOTS MUST BE CUT CLEANLY AND A BITUMINOUS FUNGICIDAL SEALANT APPLIED TO THE CUT
- BACKFILL AROUND TREE ROOTS USING A MIXTURE OF THREE PARTS TOPSOIL TO ONE PART COMPOST, LIGHTLY COMPACTED
- EXCAVATION UNDER TREE CANOPIES TO BE BACKFILLED AS SOON AS POSSIBLE TOPSOIL AND SUBSOIL MUST BE STOCKPILED SEPARATELY
 PLACE APPROPRIATE SEDIMENT CONTROLS AROUND STOCKPILES

- PEACE APPROPRIATE 3 SEDIMENT CONTINUES AND CONTINUES AND CREEK OR WATER COURSE SOIL MUST NOT BE STOCKPILED WITHIN 5m OF ANY CREEK OR WATER COURSE IF YOU SUSPECT FIRE ANTS ON SITE CALL BIOSECURITY QUEENSLAND ON 13 25 23 ALL ENVIRONMENTAL PROTECTION MEASURES SHOULD BE IMPLEMENTED PRIOR TO ANY CONSTRUCTION WORK (INCLUDING CLEARING) COMMENCING.

- VEGETATION PROTECTION:
 A. TREES LOCATED ALONG THE FOOTPATH SHALL BE, TRANSPLANTED PRIOR TO CONSTRUCTION, OR REPLACED IF DESTROYED.
 B. WHEN WORKING WITHIN 4 m OF TREES, RUBBER OR HARDWOOD GIRDLES SHALL BE
- CONSTRUCTED WITH 1.8 m BATTENS CLOSELY SPACED AND ARRANGED VERTICALLY FROM GROUND LEVEL. GIRDLES SHALL BE STRAPPED TO TREES PRIOR TO CONSTRUCTION AND REMAIN UNTIL COMPLETION.
- TREE ROOTS SHALL BE TUNNELLED UNDER, RATHER THAN SEVERED. IF ROOTS ARE SEVERED THE DAMAGED AREA SHALL BE TREATED WITH A SUITABLE FUNGICIDE. CONTACT RELEVANT COUNCIL ARBORIST FOR FURTHER ADVICE ANY TREE LOPPING REQUIRED SHOULD BE UNDERTAKEN BY AN APPROVED ARBORIST.

- TOPSOIL AND SUBSOIL SHALL BE STOCKPILED SEPARATELY
- TOP SOIL AND SUBSUIL STALL BE STOCKHILED SEPARATIELT
 CARE SHALL BE TAKEN TO PREVENT SEDIMENT FROM ENTERING THE STORMWATER
 SYSTEM. THIS MAY INVOLVE PLACING APPROPRIATE SEDIMENT CONTROLS AROUND
 STOCKPILES.
- STOCKPILES.

 FIRE ANT MOVEMENT CONTROLS: THE QUEENSLAND GOVERNMENT HAS IMPLEMENTED IMPROVEMENT CONTROLS IN AREAS OF QUEENSLAND (BIOSECURITY ZONES) WHERE THIS PEST SPECIES HAS BEEN DETECTED. THESE CONTROLS APPLY TO INDIVIDUALS AND COMMERCIAL OPERATORS AND RESTRICT THE MOVEMENT OF MATERIALS THAT COULD CARRY FIRE ANTS WHICH INCLUDE SOIL, TURF, POTTED PLANTS, MULCH, BALED HAY OR STRAW, ANIMAL MANURES, MINING OR QUARRY PRODUCTS, PENALTIES FOR ONCOMPLIANCE WITH MOVEST MINING ON QUARANT PROVIDED IS PORT ON ONCOMPLIANCE WITH MOVEMENT CONTROLS WITHIN FIRE ANT BIOSECURITY ZONES APPLY UNDER THE BIOSECURITY ACT 2014. CONTRACTORS AND THEIR SUB-CONTRACTORS WILL BE LIABLE FOR BREACHES AND ARE TO FOLLOW LEGISLATION
- AT ALL TIMES.

 IF ACID SULPHATE SOILS ARE FOUND (OR ARE EXPECTED TO BE) IN THE WORKS AREA. THE OUTPUTS FROM THE RISK ASSESSMENT BASED ON THE QUEENSLAND ACID SULPHATE SOIL TECHNICAL MANUAL REQUIRES THAT ACID SULPHATE SOILS BE MANAGED AS PER LEGISLATED PROCEDURES.

- SILTATION CONTROL MEASURES SHALL BE PLACED DOWNSTREAM OF ANY EXCAVATION WORK
- APPROPRIATE SEDIMENT CONTROLS SHALL BE USED TO PREVENT SEDIMENT FROM ENTERING THE CREEK
- NO SOIL SHALL BE STOCKPILED WITHIN 5 m OF THE CREEK

- PREDISTURBANCE SOIL PROFILES AND COMPACTION LEVELS SHALL BE REINSTATED.
- PREDISTURBANCE VEGETATION PATTERNS SHALL BE RESTORED.

ACTIVITIES ARE MANAGED TO AVOID OR MINIMISE HARM TO ABORIGINAL CULTURAL HERITAGE. CONTRACTORS ARE TO FULFIL THIS DUTY OF CARE AT ALL TIMES.

DRAWN: FEB 2023

DESIGNED: FEB 2023

SAFETY NOTES

SAFETY NOTES

- CONTRACTOR IS TO COMPLETE A HAZARD AND RISK ASSESSMENT PRIOR TO CONSTRUCTION AND PROPOSE SUITABLE ACTION/RESPONSE TO ADDRESS ALL HIGH AND ABNORMAL RISK ITEMS
- TEMPORARY WARNING DEVICES TO BE FRECTED AS PER "MANUAL OF UNIFORM
- TEMPORARY WARNING DEVICES "AND RELEVANT COUNCIL QUIDELINES TO ENSURE SAFE WORKING CONDITIONS FOR WORKERS, PEDESTRIANS AND PASSING TRAFFIC. TRY TO AVOID WORKING IN CONFINED SPACES. IF CONFINED SPACES WORK CAN'T BE AVOIDED PROVIDE SAFE WORK METHOD STATEMENT (SWMS) ADDRESSING MITIGATION OF RISKS. PROVIDE ADEQUATE SIGNAGE TO TEMPORARY AND PERMANENT CONFINED PACES TO A GROSSE SPACES TO AS2865
- THE CONTRACTOR IS TO ENSURE THEY HOLD ALL RELEVANT TICKETS, CERTIFICATION AND PERMITS SUITABLE FOR THE PROPOSED WORKS PRIOR TO CONSTRUCTION
- IT IS THE CONTRACTOR'S RESPONSIBILITY TO LOCATE ALL EXISTING SERVICES ON SITE PRIOR TO CONSTRUCTION AND LAYING OF ANY SERVICES. ANY LIABILITY RESULTING
- PRIOR TO CONSTITUTION FIND HATTING OF ANY SERVICES, ANY LIABILITY RESULT
 FROM DAMAGE TO EXISTING SERVICES WILL BE BORNE BY THE CONTRACTOR.
 CONTRACTOR TO BEWARE EXISTING GAS PIPELINES IN VICINITY OF WORKS, ANI
 ENSURE AUTHORITY REQUIREMENTS ARE ADDRESSED DURING CONSTRUCTION
- ALL TRENCH EXCAVATION AND CONSTRUCTION SHALL COMPLY WITH THE
- REQUIREMENTS OF THE COMMONWEALTH WORK HEALTH AND SAFETY ACT 2011.
- REQUIREMENTS OF THE COMMONEAL IH WORK HEALTH AND SAFETY ACT 2011.

 CONSTRUCTION BARRIERS THAT CONTRIBUTE TO SAFETY, SUCH AS HANDRAILS AND

 TOE BOARDS, FALL ARREST SYSTEMS ACCESS STAIRS ETC AS EARLY AS POSSIBLE.

 PROVIDE SAFETY BARRIERS AT EDGES OF OPENINGS AND ELEVATED ARREAS.

 REVIEW ADEQUACY OF WORKING SPACE AVAILABLE FOR CONSTRUCTION ACTIVITIES.

 ENSURE SEPARATION OF PLANT AND PERSONNEL/PROPERTY ON SITE, INCLUDING
- MOVEMENT OF BOTH 10. PROVIDE PROTECTION TO AND SEPARATION FROM ELECTRICAL OVERHEAD WIRING
- PROVIDE PROTECTION TO AND SEPARATION FROM ELECTRICAL OVERHEAD WIRING SYSTEMS DURING CONSTRUCTION.

 ALL TRENCHES MORE THAN 1.5m DEEP (BASE OF TRENCH TO TOP OF TRENCH OR TOP OF SPOIL ADJACENT TO TRENCH WHICHEVER IS GREATER) ARE TO BE SHORED OR BENCHED OR BATTERED AT I INITIAL WITTEN RISK ASSESSMENTS AREA ADVISED FOR ACCESS TO OPEN EXCAVATIONS AND SAFE ACCESS IS TO BE MAINTAINED FOR ALL PERSONS IN THE TRENCH AT ALL TIMES IN CASE OF INUNDATION OR WALL COLLAPSE/ENGULFMENT
- LOCATE STOCKPILES AWAY FROM BATTERS/EXCAVATIONS AND EXISTING SERVICES SEEK ADVICE FROM SUITABLY QUALIFIED GEOTECHNICAL ENGINEER PRIOR TO
- CONSTRUCTION ACTIVITIES ADJACENT TO OPEN EXCAVATIONS AND/OR RETAINING

PERMIT & COMPLIANCE NOTES

NETWORK ACCESS PERMIT (NAP) - LIVE WORK A UU NETWORK ACCESS PERMIT MUST BE OBTAINED FROM THE UU ASSURANCE TEAM PRIOR TO THE COMMENCEMENT OF LIVE WORK ON-SITE. WORKS WITHIN 20 OF EXISTING SEWER INFRASTRUCTURE IS CONSIDERED LIVE WORKS. CONTRACTOR TO CUIDMY TO SEPARAT TO SURVINE TO SEMENT TOWNORKS ADDIL CATON. FOR SURVINE TO SERVINE TO SURVINE TO SERVINE TO SERVINE TO SURVINE TO SERVINE TO SERVINE TO SERVINE TO SERVINE TO SERVINE TO SERVINE TO SURVINE TO SERVINE THE SERVINE TO SERVINE TO SERVINE TO SERVINE TO SERVINE TO SERVINE THE SERVINE TO SERVINE TO SERVINE THE SERVINE TO SERVINE THE SERVINE TO SERVINE THE SERVINE TH TO SUBMIT 'PERMIT TO WORKS APPLICATION'. FOR FURTHER INFORMATION PLEASE CONTACT UU ACCESS TO ASSETS COORDINATOR ON PH: 3856 7160 OR FMAIL: DEVELOPMENT.PERMITS@URBANUTILITIES.COM.AU. ALLOW TWENTY (20) WORKING DAYS TO PROCESS NAP PERMITS AND

IWEINLY (2U) WORKING DAYS TO PROCESS NAP PERMITS AND ASSOCIATED WATER SHUT PLANS AND/OR SEWER FLOW CONTROL PLANS.

(WATER) SHUT PLAN:

PRIOR TO COMMENCEMENT OF WATER MAIN WORKS ON-SITE, A UU NETWORK ACCESS PERMIT (AND ASSOCIATED SHUT PLAN'S) MUST BE OBTAINED FROM THE UU NETWORK ACCESS TEAM

(SEWER) FLOW CONTROL PLAN:

PRIOR TO COMMENCEMENT OF SEWER WORKS ON-SITE, A UU
NETWORK ACCESS PERMIT (AND ASSOCIATED FLOW CONTROL
PLANIS) MUST BE OBTAINED FROM THE UU NETWORK ACCESS TEAM

LIVE WORKS

UNDER NO CIRCUMSTANCES SHALL THE CONTRACTOR PERFORM ANY LIVE WORKS WITHOUT PRIOR APPROVAL/CONSENT AND RECEIPT OF NECESSARY PERMITS FROM ENDORSED CONSULTANT AND URBAN UTILITIES

CONSTRUCTION INSPECTIONS:

UTILITIES'S AUDIT & COMPLIANCE OFFICER AT LEAST THREE (3) DAYS PRIOR TO COMMENCEMENT OF CONSTRUCTION. PLEASE CONTACT 073856 7161 OR FMAIL

DEVELOPMENT.AUDIT@URBANUTILITIES.COM.AU

COMPLIANCE INSPECTIONS, AS-CON DOCUMENTATION &

THE CONTRACTOR IS RESPONSIBLE TO MAINTAIN COMMUNICATION WITH THE CLIENT, UU. ENDORSED CONSULTANTS AND MELIORA ENGINEERING REGARDING PROGRAM AND TIMING OF CONSTRUCTION PHASE

ALL COMPONENTS OF UU WORKS MAY BE SUBJECT TO INSPECTION REQUIREMENTS. THE CONTRACTOR IS TO ALLOW FOR THE BELOW INSPECTIONS AT A MINIMUM, AS WELL AS REQUEST FOR AUDITS AS PER UU PROCESSES. THE CONTRACTOR IS TO PROVIDE NOTICE IN WRITING TO MELIORA ENGINEERING (AND CC IN CLIENT TO EMAILS) A MINIMUM OF THREE (3) BUSINESS DAYS PRIOR TO INSPECTIONS.

THE FOLLOWING INSPECTIONS (WITNESS HOLD POINTS) ARE MANDATORY FOR THE WORKS:

- LULE WORKS CONNECTION (WITNESSED BY UU AS REQUIRED VIA AUDIT REQUEST; SEWER / WATER PIPES IN TRENCH, PRIOR TO BACKFILL SEWER MANHOLE BASE, PRIOR TO BACKFILL SEWER MANHOLE BASE, PRIOR TO BACKFILL SEWER MANHOLE LIFT PRIOR TO ASPRO

- COMPLETED ASPRO
- VISUAL INSPECTION OF WATER ASSEMBLY FOR LEAKS

UU WORKS COMPLETION / ON-MAINTENANCE

IN ADDITION TO FACILITATING ENGINEERING INSPECTIONS, THE CONTRACTOR IS TO MAINTAIN COMPREHENSIVE CONSTRUCTION RECORDS TO SATISFY UUS "AS-CONSTRUCTED PACKAGE CERTIFICATION" FORM AS FOUND ON UU WEBSITE, INCLUDING (BUT NOT LIMITED TO) PHOTOS OF ALL STAGES OF CONSTRUCTION, AS-CONSTRUCTED SURVEY, ADAC XML, MATERIAL DOCKETS, CCTV, PRESSURE TESTS, BACTERIAL TESTS, EVIDENCE OF FLUSHING, TRENCH COMPACTION TESTS) AND IS TO ISSUE TO MELIORA ENGINEERING AND THE ENDORSED CONSULTANT AT THE END OF EACH WEEK, IT IS THE CONTRACTOR'S ENDORSED CONSULTANT AT THE END OF EACH WEEL. IT IS THE CONTRACTORS

RESPONSIBILITY TO SCHEDULE THE TESTING AND AS-CONSTRUCTED PICKUP TO SATISFY UU

REQUIREMENTS. UNDER NO CIRCUMSTANCES WILL NEW UU WORKS BE PERMITTED TO BE

MADE "LIVE" UNTIL ALL TESTING HAS BEEN RECEIVED AND APPROVED BY UU.

CONTRACTUALLY, IF AS-CONSTRUCTED PICKUP IS $\underline{\text{NOT}}$ PART OF THE CONTRACTOR'S SCOPE OF WORKS, THE CONTRACTOR MUST COORDINATE THE WORKS WITH THE NOMINATED SURVEYOR, AND GIVE AS MUCH NOTICE AS PRACTICABLE TO PROGRAM THE SURVEY

PLEASE NOTE THAT RPEQ CERTIFIED CONSTRUCTION CERTIFICATION CANNOT BE PROVIDED WHERE MELIORA (OR THE ENDORSED CONSULTANT) HAS NOT ATTENDED INSPECTIONS AND ADEQUATE AS-CONSTRUCTED DOCUMENTATION HAS NOT BEEN SUPPLIED. CONTRACTOR IS LIABLE FOR ALL COSTS & RE-WORK REQUIRED WHERE ADEQUATE CONSTRUCTION INSPECTIONS/RECORDS HAVE NOT BEEN FACILITATED & SUPPLIED

GEOTECHNICAL SUPERVISION & CERTIFICATION
WHERE COMPACTION IS REQUIRED TO TRENCH BACKFILL, CERTIFICATION IS TO BE PROVIDED BY A GEOTECHNICAL ENGINEERING TO CONFIRM FIT FOR USE TO SATISFY UU REQUIREMENTS

PNT CONDITION COMPLIANCE
CONTRACTOR TO REVIEW AND CONSTRUCT ALL WORKS IN
ACCORDANCE WITH UU DECISION NOTE 23-PNT-64086

URBAN UTILITIES

THIRD PARTY CERTIFICATION SCHEME ENDORSED CONSULTANT
(PLANS SUBMITTED ARE TO URBAN UTILITIES' STANDARDS AND SATISFY THE WATER

WATER APPROVAL REF NUMBER: 23-PNT-64086

ENDORSED CONSULTANT: DMC QLD CONSULTING PTY LTD RPEQ NAME: DIANA CAMPBELL - 4945

RPEQ SIGNATURE: RPEQ CONTACT DETAILS: 07 3881 2350



REFERENCE PRECEDENCE
REFER TO REQUIREMENTS OF THE FOLLOWING MANDATORY REFERENCE DOCUMENTS (IN ORDER OF PRECEDENCE). REQUEST IF NOT RECEIVED DURING TENDER, CONTRACTOR WILL BE LIABLE FOR NON-COMPLIANT CONSTRUCTION. RAISE DISCREPANCIES WITH SUPERINTENDENT

WATER AUTHORITY APPROVED PLANS/DOCUMENTS
WATER AUTHORITY APPROVAL CONDITIONS
WATER AUTHORITY STANDARDS, GUIDELINES AND POLICY
DESIGN STANDARD & GUIDELINES (SEQ CODE, WSAA)
PROJECT DRAWINGS, NOTES AND DETAILS

FOR CONSTRUCTION

MELIORA JOB N C51

Α REVISION

2270



ALL PLANS TO BE READ IN CONJUNCTION WITH INFORMATION AND NOTES ON DRG. No. C01 & C50 AND ALL RELEVANT SPECIFICATIONS







11 SHANAHAN PARADE, REDBANK PLAINS

PROSPERITY CAPITAL PRINCIPLES PL

SEWER & WATER GENERAL NOTES

ISSUE FOR CONSTRUCTION 17.02.23 SM MB

SEWER NOTES

- NICHAL

 CONCRETE SHALL BE CLASS N20 TO WSA PS-357 EXCEPT FOR MAINTENANCE HOLES WHICH ARE SPECIAL CLASS TO WSA PS-358 WITH CALCAREOUS AGGRECATES

 ALL PIPES, FITTINGS AND CONCRETE SHALL HAVE A MINIMUM COVER OF 1150mm IN FOOTPATHS AND ROADWAYS WHERE SEWERS HAVE A GRADE OF 1 IN 20 OR STEEPER, BULKHEADS SHALL BE CONSTRUCTED IN ACCORDANCE WITH THE SEQ SEWER CODE.

 SEWERS SHALL BE DISUSED IABANDONED IN ACCORDANCE WITH PROCEDURES SET OUT IN THE SEQ SEWER CODE
- SEWERS SHALL BE DISUSED JABANDONED IN ACCORDANCE WITH PROCEDURES SET OUT IN THE SED SEWER CODE CONSTRUCTION OF THE PROPOSED SEWER MORKS TO BE LUNDERTHALE BY A PRIVATE CONTRACTOR. THE ENDORSED CONSULTANT IS TO INSPECT AND COORDINATE TESTINS OF ALL WORK TO ENSURE ITS QUALITY AND THAT IT CONFORMS WITH ULU STANDARDS. THE CONTRACTOR IS TO NOTIFY THE ENDORSED CONSULTANT AND ULAND OSTAIN RELEVANT PERMITS PRIOR TO COMMENCEMENT OF WORKS CONTRACTOR SHALL VERIFY FINISHED SURFACE LEVELS ON SITE BEFORE CONSTRUCTION OF SEWERS AND PROPERTY CONNECTIONS. THE CONTRACTOR SHALL ENSURE THAT AS CONSTRUCTED DETAILS CAN BE COLLECTED BY SURVEYOR UNDER SUPERVISION OF SEWERS AND TIS THE DEVELOPER'S RESPONSIBILITY TO ENSURE ALL LIVE SEWER WORKS ARE COMPLETE BEFORE ALL OWING PRIVATE DRAINARS TO BE CONNECTED.

- IT IS THE LEVELOPER'S RESPONSIBILITY TO ENSURE ALL LIVE SEWER WORKS ARE COMPLETE BEFORE
 ALLOWING PRIVATE DRAINAGE TO BE CONNECTED
 AFTER SUCCESSFUL 'ON MAINTENANCE HOUSE DRAINS ARE TO BE CONNECTED TO NEW HC'S BY A LICENSED
 PULIMBER IN ACCORDANCE WITH APPROVED PLANS
 ANY EXISTING PROPERTIES REQUIRING SEWER WORKS ARE TO BE REINSTATED TO THEIR ORIGINAL CONDITION
 BY THE CONTRACTOR. ANY REPART AND RECTIFICATION WORK IS AT THE EMPENSE OF THE CONTRACTOR. WRITTEN
 PERMISSION MUST BE OBTAINED FROM OWNERS BEFORE ENTERING PROPERTY TO CONSTRUCT PROPOSED
- PERMISSION MUST BE USIANED HAWM UNWERN BETWEE BY IRRING PROFERT TO SALEMENT OF THE SEVERE WORKS.

 THE CONTRACTOR IS RESPONSIBLE FOR OBTAINING ALL NECESSARY PERMITS TO ALLOW CONSTRUCTION OF THE SEWER KNOWN CONSTRUCTION AND SAPE SHORING TO ALLOW FOR LIVE SEWER WORKS (INCLUDING INSPECTION). THE MINIMUM CLEARANCE TO OTHER SERVICES IS TO BE IN ACCORDANCE WITH THE CURRENT SEQ WATER SUPPLY AND SEWERED EDSIGN & CONSTRUCTION COOK UNLESS OTHERWISES HOWN.

 CONTRACTOR TO OBTAIN PRIOR APPROVAL OF UL AND RPEQ ENGINEER FOR ANY AND ALL MINOR DEVIATIONS.
- REQUIRED TO AVOID EXISTING SERVICES
 VACUUM TESTING & CCTV TO BE CARRIED OUT IN ACCORDANCE WITH THE SEQ WATER SUPPLY AND SEWERAGE
- VACUUM TESTING & COTY TO BE CARRIED OUT IN ACCORDANCE WITH INE SEQ WALLEN SUPPLY AND SEXTETUNGS.

 DESIGN & CONSTRUCTION CODE

 INSTALL DETECTABLE MARKER TAPE ON ALL MAINS AND PROPERTY CONNECTIONS. REFER TO UU STANDARDS.

 PIPELINES SHALL NOT BE CONSTRUCTED IN UNCONTROLLED FILL. CERTIFICATES SHALL BE LODGED WITH THE

 CONTRACT MANAGER AND THE UU AUDIT & COMPLIANCE OFFICER CERTIFING THE FILL IS CONTROLLED FILL

 COMPACTED TO A DENSITY OF NO LESS THAN SW, OF ITS STANDARD MAXIMUM POY POENSITY, IN ACCORDANCE

 WITH A. S. 1289 5.1.1. WHERE PIPES ARE LAD IN FILL. THE FILLING SHALL BE CARRIED OUT IN LAYERS NOT

 EXCEEDINGS 300 mm (LOOSE) IN DEPTH AND SHALL BE COMPACTED UNITL THE COMPACTION IS NOT LESS THAN 95%

 OF THE MATERIALS MAXIMUM COMPACTION WHEN TESTED IN ACCORDANCE WITH A. S. 1289 (MODIFIED

 COMPACTION). TESTING SHALL BE CARRIED DUT AFTER EACH ALTERNATE LAYER IN ALL SUCH CASSES APPROVAL

 OF CONSTRUCTED SEWERS WILL NOT BE ISSUED BY THE SEQ SERVICE PROVIDER UNLESS CERTIFICATES ARE

 PROPULAGE CORSTRUCTED SEWERS WILL NOT BE ISSUED BY THE SEQ SERVICE PROVIDER UNLESS CERTIFICATES ARE

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- OF CONSTRUCTED SEWERS WILL NOT BE ISSUED BY THE SES SERVICE PROVIDER UNLESS CERTIFICATES ARE PRODUCED EETFITHING THAT THE FEQUIRED COMPACTION HAS BEEN ACHIEVED TUNNEL BORE OR DIRECTIONAL DRILL UNDER EXISTING STAMPED OR REINFORCED CONCRETE DRIVEWAYS WHERE THE EXISTING SURFACE CANNOT BE MATCHED, AND UNDER SIGNIFICANT TREES AS ADVISED BY LOCAL COLUNCIL ALL SEWERAGE RETICULATION OR PROPERTY CONNECTIONS CROSSING ROADS ARE TO INCLUDE KERB MARKINGS TO SEQ. SEW-1103-3

- MAINTENANCE HOLES

 1. ALL UU MANHOLES TO BE IN ACCORDANCE WITH NOTES ON STD DRAWINGS SEQ-SEW-1101-4 THROUGH TO SEQ-SEW-1101-6
- ALL MAINTENANCE HOLES TO BE CAST IN-SITU USING SPECIAL CLASS CONCRETE (WSA PS-358) UNLESS OTHERWISE
- STATED A CONTRICTE (WSA PS-358) TO BE: STRENGTH CLASS 40MPa AGGREGATE SIZE 20mm SLUMP AT POINT OF ACCEPTANCE TO BE IN THE RANGE 80mm TO 120mm. ONLY CALCAREOUS AGGREGATES TO BE USED. CALCAREOUS AGGREGATES ARE AGGREGATES DEFINED AS HAWING AN ACID SOLUBITY GREATER THAN 88%.
- CALCAREOUS AGGREGATES ARE AGGREGATES DEFINED AS HAVING AN ACID SOLUBILITY GREATER THAN 98% WHEN TESTED IN ACCORDANCE WITH AWAW B 100-09.

 IF THIS SPECIAL CLASS CONCRETE TYPE CANNOT BE SOURCED, THEN RPEO ENGINEER IS TO BE NOTIFIED AND APPROVAL IS TO BE SOURCH FOR MANHOLES TO BE LINED WITH A CAST IN PLACE LINING SYSTEM AS PER THE SEQ CODE STANDARD DRAWINGS SECORS—1407-14 AND SEC-SPS-1407-16 ND SEC-SPS-1407-16 N

- SEWERAGE DESIGN & CONSTRUCTION CODE. STEP IRONS & FIXING METHOD TO BE IN ACCORDANCE WITH AS 1657

TRENCH NOTES

- EINCH INCHES

 GEOTECHNICAL ENGINEER TO CONFIRM IF TRENCH SUPPORT IS REQUIRED PRIOR TO CONSTRUCTION

 PIPE EMBEDMENT MATERIAL SHALL BE 5 TO 7mm SINGLE SIZED MATERIAL. THAT COMPLIES WITH THE PURCHASE

 SPECIFICATION FOR EMBEDMENT MATERIALS AS NOMINATED BY UU IN THE SEQ ACCEPTED PRODUCTS &

 MATERIALS IS LIST.
- MINIMUM COVER ON MAINS FROM PERMANENT LEVEL SHALL BE THE GREATER OF SEQ WS&S D&C CODE DWG NO SEQ-SEW-1200-2 OR BRISBANE CITY COUNCIL STANDARD DRAWINGS BSD-2042 & BSD-2043 ROAD CROSSINGS, VERGES AND PATHS TRENCH RESTORATION SHALL BE IN ACCORDANCE WITH BCC STANDARD
- DRAWING BSD-2042 & BSD-2043
 PROVIDE 50 THICK LAYER OF BEDDING SAND IF FLOWABLE FILL CONCRETE OR OTHER LOW PERMEABLE FILL IS
 USED AS PRIFEDIMENT
- 150 MINIMUM OVERLAY FOR NON TRAFFICABLE AND 300 MINIMUM FOR TRAFFICABLE. REFER STANDARD DRAWING SEC-SEW-1200-2
- FOR PE SEWER, WHERE TRENCH FILL IS A MIGRATORY NATIVE SOIL OR SAND OR FINE CLAY MATERIAL. EMBEDMENT
- FOR PE SEWER, WHERE TRENCH FILL IS A MIGRATORY NATIVE SOIL OR SAND OR FINE CLAY MATERIAL, EMBEDMENT TYPE 4 IS TO BE USED WITHER GEOTECHNICAL INVESTIGATION RESULTS ALLOW GEOTECHNICAL INVESTIGATION RESULTS ALLOW GEOTECHNICAL ENGINEER TO CONFIRM IF TRENCH SUPPORT IS REQUIRED PRIOR TO CONSTRUCTION WHERE PIPES ARE LAID IN FILL, THE FILLING SHALL BE CARRIED OUT IN LAYERS NOT EXCEEDING 300 mm (LOOSE) IN DEPTH AND SHALL BE COMPACTED UNITL THE COMPACTION IS NOT LESS THAN 95% OF THE MATERIALS MAXIMUM COMPACTION WHEN TESTED IN ACCORDANCE WITH A. S. 1289 (MODIFIED COMPACTION). TESTING SHALL BE CARRIED OUT AFTER FACH A TERNATE LAYER, IN ALL SUCH CASES APPROVAD OF CONSTRUCTED SEWERS WILL NOT BE ISSUED BY THE SEQ SERVICE PROVIDER UNLESS CERTIFICATES ARE PRODUCED CERTIFYING THAT THE REQUIRED COMPACTION AS SEEN ACHIEVED.
- COMPACTION HAS BEEN ACHIEVED TRENCH BACKFILL TO BE IN ACCORDANCE WITH SEQ-SEW-1200-2 AND 1201-1

- IN ACCORDANCE WITH UU REQUIREMENTS AND THE CURRENT SEQ WATER SUPPLY AND SEWERAGE DESIGN AND IN ACCORDANCE WITH DIRECTIONS AND THE CHRISTIC SELECTION SELECTION SERVED AND SERVEN SELECTION OF THE ASSESSMENT AND SERVEN SELECTION SERVED AND SERVEN SELECTION SELECTION SERVED AND SERV

PRIVATE PROPERTY ACCESS

1. THE PROJECT PROPONENT MUST UNDERTAKE AND RESOLVE ALL MATTERS REGARDING ENTRY INTO PRIVATE PROPERTY INCLUDING CONSTRUCTION ACCESS, AT THE PROJECT PROPONENTS OWN COST. NO WORK SHALL COMMENCE WITHIN ANY PRAVATE PROPERTY UNIT, the PROJECT PROPONENT HAS VERIFIED THAT ALL REQUIRED OWNERS CONSENTS AND APPROVALS ARE IN PLACE AND THAT ALL OWNERS/RESIDENTS HAVE BEEN PROVIDED WITH THE NECESSARY NOTICES OF

- PROPERTY CONNECTION NOTES

 1. EACH ALLOTMENT SHALL BE SERVED BY A DINT 0 PE PROPERTY CONNECTION. FOR ALLOTMENTS OTHER THAN SINGLE RESIDENTIAL A DINTS 0 PE PROPERTY CONNECTION SHALL BE PROVIDED U.N.O.

 2. PROPERTY CONNECTION BERANCHES SHALL EXTEND BITO THE PROPERTY A MINIMUM OF 300mm AND A MAXIMUM OF 750mm.

 3. PROPERTY CONNECTION JUNICTIONS SHALL BE FOLKED THE PROPERTY A MINIMUM OF THE NOTE OF THE PROPERTY CONNECTION JUNICTIONS SHALL BOT DESCRIPTION OF THE PROPERTY CONNECTION SHALL NOT BE GREATER THAN 3.5m FROM THE DOWNSTREAM ALIGNMENT

 5. PROPERTY CONNECTION BRANCHES OF DINT 05 HALD BE GRADED AT A MINIMUM OF 1 IN 05.

 5. THE OBSERVE LEVEL OF THE PROPERTY CONNECTION DIA ALL NOT BE LOWER THAN THE OBVERT LEVEL OF THE PROPERTY CONNECTION DIA ALL NOT BE LOWER THAN THE OBVERT LEVEL OF THE PROPERTY CONNECTION BALL NOT BE LOWER THAN THE OBVERT LEVEL OF THE ADDRESS OF DISTORTION BALL NOT BE LOWER THAN THE OBVERT LEVEL OF THE PROPERTY CONNECTION DIA ASTRUCTURE OF THE PROPERTY CONNECTION TO A STRUCTURE.

- ALL CONNECTIONS REQUIRING TRADE WASTE REQUIRE CONNECTION TO A STRUCTURE
- NALL COMMEDITIONS REQUESTED REQUIRE COUNTY ON A STRUCTURE
 MAXIMUM IDEPTH TO PROPERTY CONNECTION INVEST SHALL BE 1500mm
 PROPERTY SERVICE PIPE SHALL BE POLYETHYLENE PIPE TO ASNZS 4130 SERIES 1 PNI6/SDR9 PE80B COLOURED BLACK WITH
 BLUE STRIPES.

WATER NOTES

- THE MINIMUM CLEARANCE TO EXISTING SERVICES IS TO BE IN ACCORDANCE WITH THE SEQ WATER SUPPLY AND

- MARKER TAPE MUST BE GREEN PIPELINES SHALL NOT BE CONSTRUCTED IN UNCONTROLLED FILL. CERTIFICATES SHALL BE LODGED WITH THE CONTRACT
- PIPELINES SHALL NOT BE CONSTRUCTED IN UNCONTROLLED FILL. CERTIFICATES SHALL BE LODGED WITH ECONTR MANAGER AND THE UI A JUDIT & COMPLIANCE OFFICER CERTIFYING THE FILL IS CONTROLLED FILL COMPACTED TO A DENSITY OF NO LESS THAN 95% OF ITS STANDARD MAXIMUM DRY DENSITY, IN ACCORDANCE WITH A.S. 1289.5.1.1. ALL OPEN ENDS OF DISUSED WATER MAINS MUST BE EFFECTIVELY PLUGGED DISUSED WATER MAINS MUST BE EFFECTIVELY PLUGGED DISUSED WATER MAINS MUST SET OUT IN WASA'EQU'UL STANDARDS PRIME, CAULK AND WRAP ALL BURIED FLANGES AND BOLTS WITH DENSO PETROLATUM PRODUCTS OR

- EQUIVALENT AS PER THE MANUFACTURER'S RECOMMENDATIONS
 TUNNEL BORE OR DIRECTIONAL DRILL UNDER EXISTING STAMPED OR REINFORCED CONCRETE DRIVEWAYS WHERE THE EXISTING SURFACE CANNOT BE MATCHED. AND UNDER SIGNIFICANT TREES AS ADVISED BY LOCAL COUNCIL.
- 10 WATER SERVICES:

- MIST BE BYPASSED WHERE NECESSARY
 MUST BE BYPASSED WHERE NECESSARY
 MUST BE RECONNECTED TO NEW MAIN UPON CLEARANCE BY UU
 ALL DN15mm SERVICES MUST BE RE-LAID IN DN20mm COPPER OR PE IN ACCORDANCE ACCORDANCE WITH SEQ WATER
- ALL GALVANISED IRON OR LEAD SERVICES MUST BE RE-LAID IN COPPER OR PE OF EQUIVALENT
- DIAMETER IN ACCORDANCE WITH SEQ WATER SUPPLY CODE. MUST BE INDICATED ON 'AS CONSTRUCTED' DRAWINGS.
- PE SERVICES MUST HAVE DETECTABLE MARKING TAPE PLACED ABOVE THE EMBEDMENT. WHERE THE PE
- (F) PE SERVICES MUST HAVE DETECTABLE MARKING TAPE PLACED ABOVE THE EMBEDMENT. WHERE THE PE SERVICE IS PLACED INSIDE A CONDUIT, THE DETECTABLE MARKING TAPE MUST ALSO BE PLACED IN THE CONDUIT

 11. ALL VALVES, FIRE HYDRANTS AND SURFACE FITTINGS ON DISUSED WATER MAINS MUST BE REMOVED UNLESS NOTED TO SURFACE FITTINGS ON DISUSED WATER MAINS MUST BE REMOVED UNLESS.
- 12. ALL FLANGES MUST BE PN16 AND IN ACCORDANCE WITH A.S. 4087 UNLESS NOTED OTHERWISE
- WHERE A METALLIC WATER MAIN IS TO BE REPLACED WITH A PLASTIC MAIN, A LICENSED ELECTRICIAN SHALL MAKE AN 13. WHERE A MEHALLIC WALER MAIN IS TO BE REPLACED WITH A PLASTIC MAIN, A LICENSED ELECTRICIAN SHARE AN ASSESSMENT OF POTENTIALLY AFFECTED PROPERTY EARTHING SYSTEMS. WORK SHALL NOT COMMENCE UNTIL THE ELECTRICIAN DECLARES IN WRITING THAT IT IS SAPE TO PROCEED

 14. PIPE EMBEDMENT MATERIAL SHALL BE 5 TO 7mm SINGLE SIZED MATERIAL THAT COMPLIES WITH THE PURCHASE SPECIFICATION FOR EMBEDMENT MATERIALS AS NOMINATED BY UU IN THE SEQ ACCEPTED PRODUCTS & MATERIALS LIST COVER ON MAINS FROM PERMANENT LEVEL TO BE AS FOLLOWS:

63, 100 & 150 DIAMETER PIPE - 600mm 200, 250 & 300 DIAMETER PIPE - 1000mm.

MILD STEEL PIPES:

- MILD STEEL PIPES AND FITTINGS SHALL COMPLY WITH A.S. 1579 AND BE CEMENT LINED IN ACCORDANCE WITH A.S. 1281
- EXTERNAL COATINGS ON THE PIPES AND FITTINGS SHALL BE FUSION BONDED MEDIUM DENSITY POLYETHYLENE
- COMPLYING WITH A S.4321 (SINTAKOTE II)
 ALL MILD STEEL FITTINGS (BRANCHES ETC.) TO BE WELDED IN ACCORDANCE WITH THE SEQ WATER SUPPLY AND
- SEWERAGE DESIGN & CONSTRUCTION CODE

THRUST & ANCHOR BLOCKS:

- PROVIDE ANOTHOR BLOUCKS.

 PROVIDE ANOTHOR AND THRUST BLOCKS DESIGNED FOR 1200 kPa TEST PRESSURE IN ACCORDANCE WITH THE CURRENT SEQ WATER SUPPLY AND SEWERAGE DESIGN & CONSTRUCTION CODE
 THE BEARING FACE OF THE THRUST RESTRAINT MUST BE CAST AGAINST UNDISTURBED GROUND
 CONCRETE MUST NOT SPILL OVER SOCKET JOINTS
 VERTICAL THRUST BLOCKS MUST BE EMBEDDED AT A MINIMUM OF 250mm INTO UNDISTURBED GROUND

- CONCRETE MUST BE CURED 48 HOURS (MIN) PRIOR TO CHARGING MAIN
- UNREINFORCED CONCRETE SHALL BE A MINIMUM OF N20. REINFORCED CONCRETE SHALL BE A MINIMUM OF N25.
- THE CONTRACTOR SHALL CONFIRM BEARING CAPACITY PRIOR TO CONSTRUCTION OF THRUST BLOCK. SHOULD ACTUAL GROUND CONDITIONS DIFFER TO THOSE OF THE DESIGN, RE-DESIGN FOR THRUSTIANCHOR BLOCKS MAY BE REQUIRED.

TRENCH NOTES:

- MINIMUM COVER ON MAINS FROM PERMANENT LEVEL SHALL BE THE GREATER OF SEQ WS&S DC CODE DWG. NO.
 SEQ-WAT-1200-2 OR BRISBANE CITY COUNCIL STANDARD DRAWINGS BSD 2042 & BSD 2043
 ROAD CROSSING, VERGES AND PATHS TRENCH RESTORATION SHALL BE IN ACCORDANCE WITH BCC STANDARD DRAWING
- PROVIDE 50 THICK LAYER OF BEDDING SAND IF FLOWABLE FILL CONCRETE OR OTHER LOW PERMEABLE FILL IS USED AS
- 150mm MINIMUM OVERLAY FOR NON TRAFFICABLE AND 300mm MINIMUM FOR TRAFFICABLE

- DUCTILE IRON CEMENT LINED PIPES (DICL):

 1. ALL DICL PIPES AND FITTINGS TO BE WRAPPED WITH POLYETHYLENE SLEEVING AS PER THE MANUFACTURERS
- RECOMMENDATIONS
 DICL PIPES AND NON-FLANGED FITTINGS MUST BE PN35 AND COMPLY WITH A.S. 2280
 FLANGED DICL FITTINGS SHALL BE PN16 AND COMPLY WITH A.S. 2280
- WATER SERVICE, METERS AND CONDUIT NOTES

 1. SINGLE DWELLING SERVICE PIPE TO 20m IN LENGTH IS DN25

 2. SINGLE PROPERTY SERVICE PIPE OVER 20m IN LENGTH IS DN32
- TWIN PROPERTY SERVICE PIPE TO 20m IN LENGTH SHALL BE DN32 WHERE THE MAIN TAP BALL VALVE IS DN20 AND THE
- TWIN PROPERTY SERVICE PIPE A TETER THE SPLITTER TEE IS DIVEZ, WHITE IT HE WHIN HE PAIL SEC-WAT-1107. VALVE IS DIVEZ AND THE INDIVIDUAL PROPERTY SERVICE PIPE AFTER THE SPLITTER TEE IS DIVEZ, REFER DETAIL SEC-WAT-1107. METER BOX INSTALLATION REFER TO SEC-WAT-1107.3. SMALL DIAMETER METERS TO BE WRAPPED IN GEOFABRIC. METER INSTALLATION FORM TO BE PROVIDED TO MELIORA ENGINEERING BY THE CONTRACTOR AFTER THE CONTRACTOR INSTALLS METER BOX.
- PROPERTY SERVICE PIPE STAMPED IDENTIFICATION TAG (35 MIN DIA) SHALL BE STAINLESS STEEL RETAINED BY A
- STAINLESS STEEL PIN
 PROPERTY SERVICE PIPE, BALL VALVES, DUCTILE IRON PRE-TAPPED PROPERTY SERVICE FITTING AND ASSOCIATED FITTINGS SHALL BE JOINTED IN ACCORDANCE WITH THE MANUFACTURER'S RECOMMENDATIONS.
- THE MAIN TAP BALL VALVE SHALL BE LEFT IN THE FULLY OPEN POSITION THE WATER METER BALL VALVE WITHIN BOX SHALL BE LEFT IN THE FULLY CLOSED POSITION
- PROVIDE PROPERTY SERVICE MARKER TAPE FOR BURIED PIPE.
 ALL SERVICE CONDUITS TO BE DN100 uPVC SOLVENT WELD JOINT

URBAN UTILITIES

THIRD PARTY CERTIFICATION SCHEME ENDORSED CONSULTANT (PLANS SUBMITTED ARE TO URBAN UTILITIES' STANDARDS AND SATISFY THE WATER

WATER APPROVAL REF NUMBER: 23-PNT-64086 ENDORSED CONSULTANT: DMC QLD CONSULTING PTY LTD

RPEQ NAME: DIANA CAMPBELL - 4945 RPEQ SIGNATURE:

RPEQ CONTACT DETAILS: 07 3881 2350



REFERENCE PRECEDENCE
REFER TO REQUIREMENTS OF THE FOLLOWING MANDATORY REFERENCE DOCUMENTS (IN ORDER OF PRECEDENCE). REQUEST IF NOT RECEIVED DURING TENDER, CONTRACTOR WILL BE LIABLE FOR NON-COMPLIANT CONSTRUCTION. RAISE DISCREPANCIES WITH SUPERINTENDENT

WATER AUTHORITY APPROVED PLANS/DOCUMENTS
WATER AUTHORITY APPROVAL CONDITIONS
WATER AUTHORITY STANDARDS, GUIDELINES AND POLICY
DESIGN STANDARD & GUIDELINES (SEQ CODE, WSAA)
PROJECT DRAWINGS, NOTES AND DETAILS

FOR CONSTRUCTION

A ISSUE FOR CONSTRUCTION 17.02.23 SM MB REV DESCRIPTION

DIAL BEFORE YOU DIG

ALL PLANS TO BE READ IN CONJUNCTION WITH INFORMATION AND NOTES ON DRG. No. C01 & C50 AND ALL RELEVANT SPECIFICATIONS

> DRAWN: FEB 2023 DESIGNED: FEB 2023

MELIORA



PO BOX 694 BURPENGARY, QLD 4505

PROSPERITY CAPITAL PRINCIPLES PL


11 SHANAHAN PARADE, REDBANK PLAINS

SEWER & WATER TECHNICAL NOTES

2270 MELIORA JOB No

C52

Α REVISION

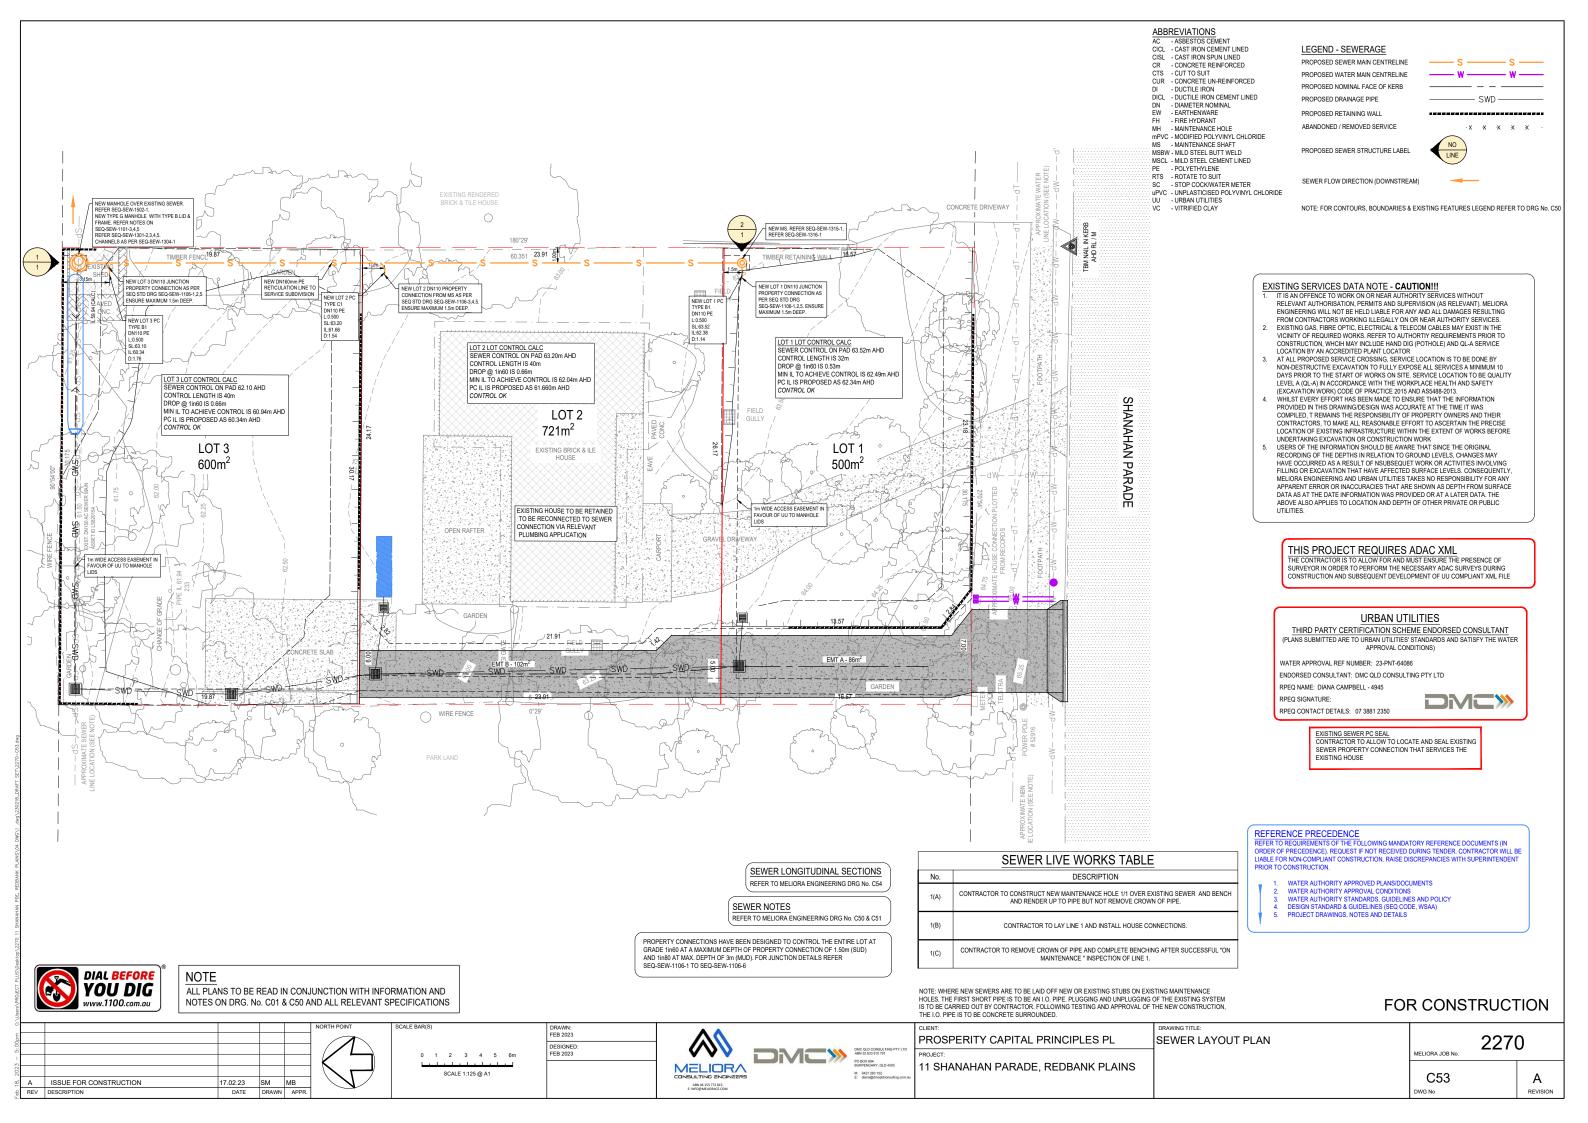

SEQ DESIGN NOTES

- NOTE
 1. ALL LEVELS, CHAINAGES & DISTANCES IN METRES
 2. REFER SEQ-SEW-1200 SERIES FOR BEDDING & BACKFILL REQUIREMENTS.
 3. REFER SEC-SEW-1200 SERIES FOR MAINTENANCE STRUCTURE TYPES AND DROPS AND FOR NUSEWER COMPLIANT APPURTENANCES.
 4. PIPE MATERIAL TO BE SPECIFIED AS REQUIRED BY NUSEWERS (PE).
 5. REFER SEQ-SEW-1106 SERIES FOR PROPERTY CONNECTION TYPES.
 6. DETAILS OF COMPOUND BENDS ARE TO BE SHOWN ON DESIGN DRAWINGS.

LEGEND

FP = VERGE
PP - PRIVATE PROPERTY
R = BEND RADIUS (HOR, VERT, COMP)
SRB = SHORT RADIUS BEND - 0.75 RADIUS

SRB = SHORT RADIUS BEND - 0.

L = BEND LENGTH
MH = MAINTENANCE HOLE
MS = MAINTENANCE SHAFT
PC = PROPERTY CONNECTION
TEP = TERMINAL ENTRY POINT

MAINTENANCE HOLE TYPES

G = CONCRETE 0.9000 ID (DN250mm PIPE ONLY, NO DROP, 3m MAX)
F = CONCRETE 1.2000 ID (DN350mm CONCRETE 1.2000 ID (DN300mm OR MORE PIPE)

MS = PE 0.6000 ID, 5m MAX

(PRECAST MANHOLES ARE NOT ACCEPTABLE FOR UU)

MH/MS No.	1/1
MH/MS COVER TYPE	
MH/MS TYPE	O MS
BRANCH DROP TYPE	< <
BRANCH LINE No.	
PROPERTY	ω
DATUM RL 58.7	EXISTING SURFACE (C) 16 668 (LOT 2) DESIGHN SINE CIL 61 68 68 (LOT 2)
PROPERTY DESCRIPTION	PP
PIPE NOMINAL DIAMETER (DN) TYPE	DN160 PE100 SDR21
GRADE (1inX)	19.926
PIPE LENGTH	43.878
EMBEDMENT TYPE	TYPE 4
DEPTH OF INVERT BELOW FSL	1200
INVERT LEVEL (IL)	59.386
FINISHED SURFACE LEVEL (FSL)	61.186
EXISTING SURFACE LEVEL (ESL)	63.2.13
CHAINAGE (CH)	0.0000

SEWER LONGITUNDINAL SECTION FOR LINE 1 SCALES: HORIZONTAL 1:250 VERTICAL 1:25

URBAN UTILITIES

THIRD PARTY CERTIFICATION SCHEME ENDORSED CONSULTANT (PLANS SUBMITTED ARE TO URBAN UTILITIES STANDARDS AND SATISFY THE WATER APPROVAL CONDITIONS)

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- WATER AUTHORITY APPROVED PLANS/DOCUMENTS
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A ISSUE FOR CONSTRUCTION

REV DESCRIPTION

ALL PLANS TO BE READ IN CONJUNCTION WITH ALL INFORMATION AND NOTES ON DRG. No. C01 AND ALL RELEVANT SPECIFICATIONS

17.02.23 SM MB

APPROVED: MBLYTH RPEQ No. 21258 DATE: FEB 2022








CLIENT:
PROSPERITY CAPITAL PRINCIPLES PL

SEWER LONGITUDINAL SECTION & DETAILS

FOR CONSTRUCTION

2270 11 SHANAHAN PARADE, REDBANK PLAINS C54 Α

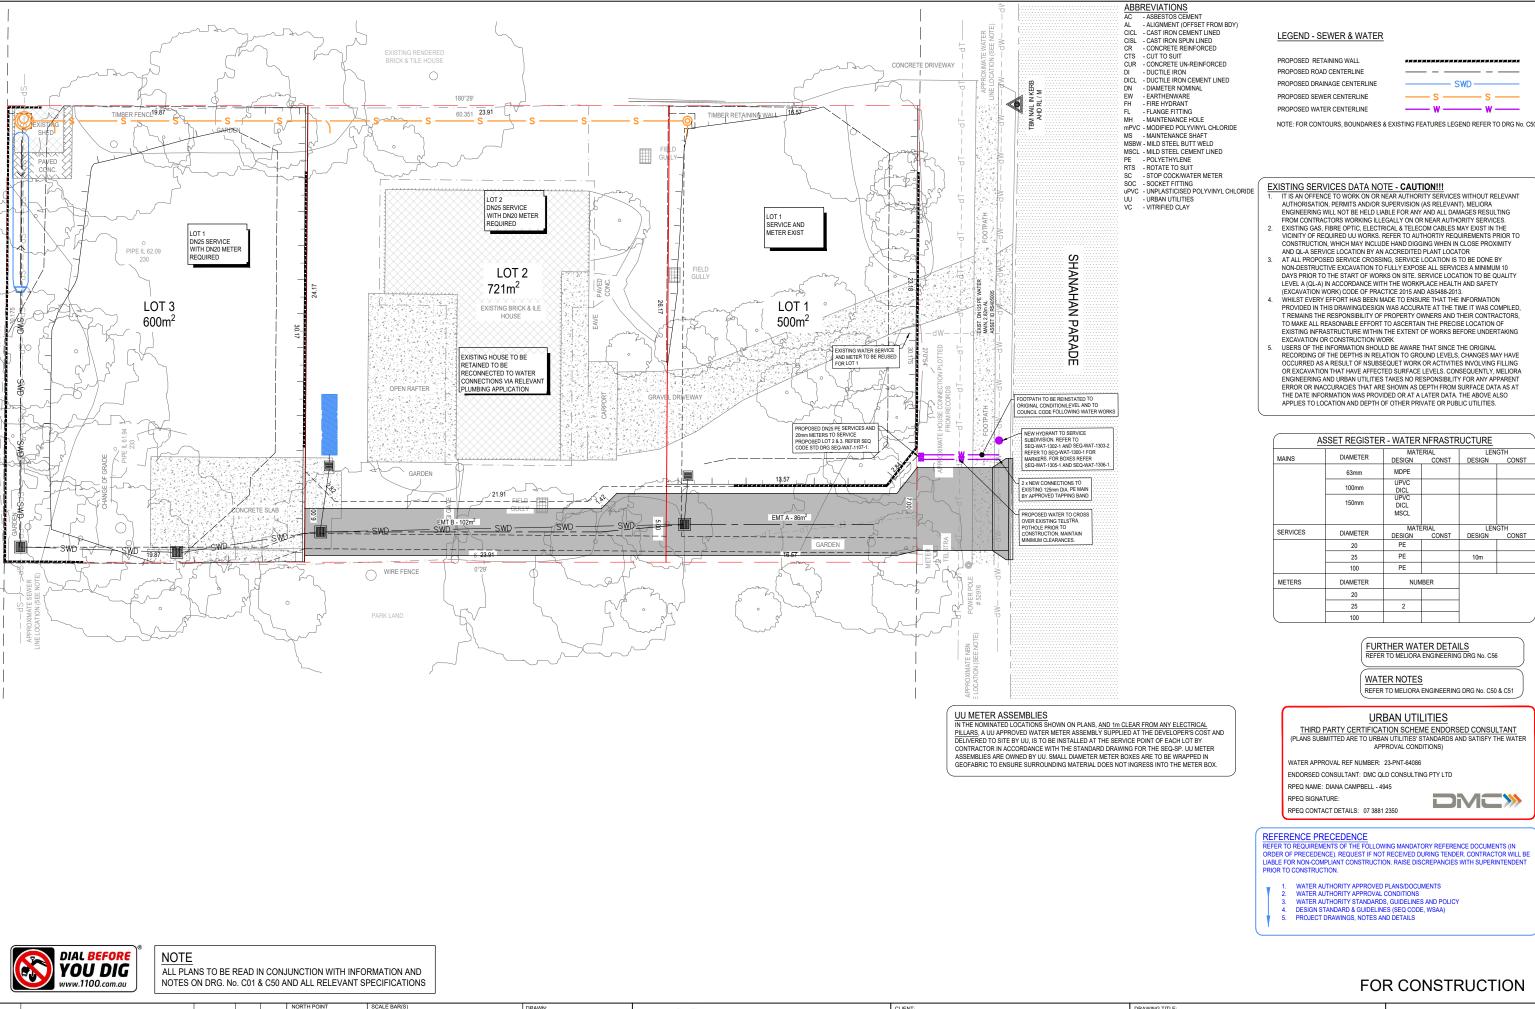

FOR CONSTRUCTION

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PROSPERITY CAPITAL PRINCIPLES PL WATER LAYOUT PLAN 2270 DESIGNED FEB 2023 PO BOX 694 BURPENGARY, QLD 4505 MELIORA 11 SHANAHAN PARADE, REDBANK PLAINS SCALE 1:125 @ A1 M: 0427 263 152 E: diana@dmcqldo C55 Α A ISSUE FOR CONSTRUCTION 17.02.23 SM MB REV DESCRIPTION